Site Development Plans

Hingham Gas #19 & 27 Whiting Street, Hingham, MA

APPLICANT:

MERHEJ & SONS REALTY, LLC

87 DERBY STREET HINGHAM, MA 02043

CHA

CIVIL ENGINEER/ ARCHITECT:

CHA CONSULTING, INC.


141 LONGWATER DRIVE, SUITE 104 NORWELL, MA 02061



LEGAL COUNSEL:

DROHAN, TOCCHIO & MORGAN

175 DERBY STREET, SUITE 30 HINGHAM, MA 02043

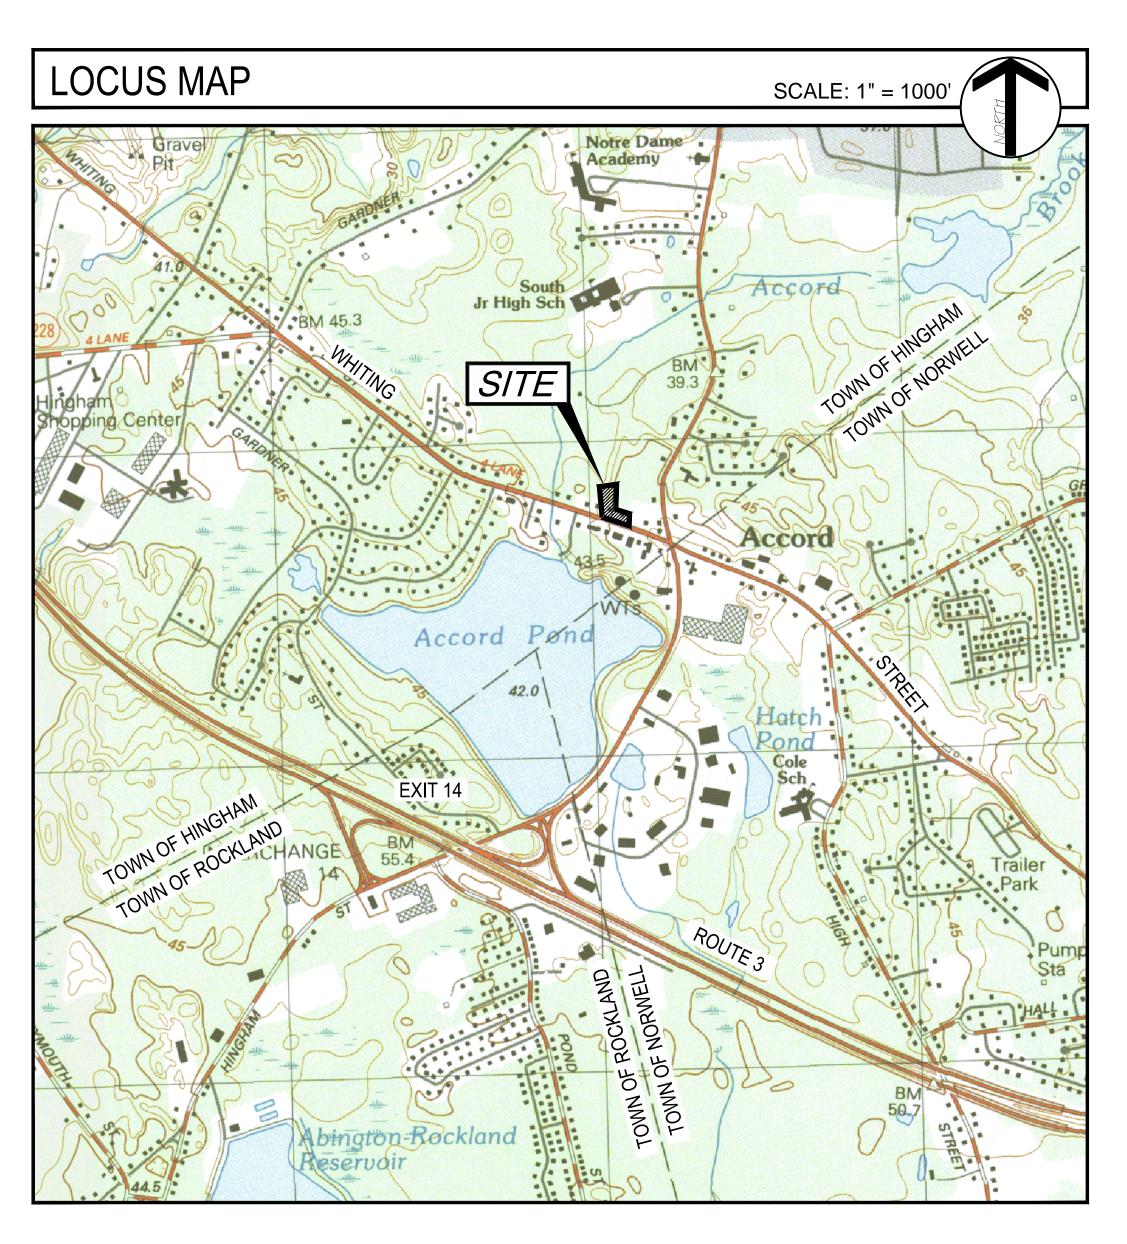


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ARCHITECTURE CONCEPT



OWNER/APPLICANT:

MERHEJ & SONS REALTY, LLC 87 DERBY STREET HINGHAM, MA 02043

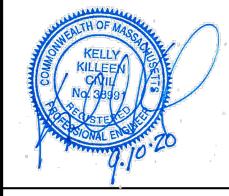

IT IS A VOLATION OF LAW FOR ANY PERSON, UNLESS THEY ACTING UNDER THE DIRECTION OF A LICENSED PROFESSION ENGINEER, ARCHITECT CT LANDSCAPE ARCHITECT OR LAND SURVEYOR TO ALTER AN ITEM IN ANY WAY. IF AN ITEM BEARIN STAMP OF A LICENSED PROFESSIONAL IS ALTERED, THE ALTE ENGINEER, ARCHITECT, LANDSCAPE ARCHITECT OR LAND SURVEYOR SHALL STAMP THE DOCUMENT AND INCLUDE TH NOTATION "ALTERED BY" FOLLOWED BY THEIR SIGNATURE, I DATE OF SUCH ALTERATION, AND A SPECIFIC DESCRIPTION

HINGHAM GAS #19 & 27 WHITING STREET HINGHAM, MA 02043

Submittal / Revision	App'd.	Ву	Date	ı
PERMIT SET	KK	JM	5/1/2020	
PERMIT SET	KK	JM	9/10/2020	
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TITLE SHEET

Designed By	Drawn By:	Checked By:
DR/BN	DR/BN	KK
Issue Date: 05/01/2020	Project No: 060903	Scale: AS SHOWN

Drawing No.:

GENERAL

- A. PROVIDE PROTECTION NECESSARY TO PREVENT DAMAGE TO EXISTING IMPROVEMENTS, TREES OR VEGETATION.
- B. PROTECT IMPROVEMENTS ON ADJOINING PROPERTIES AND ON OWNER'S PROPERTY
- C. RESTORE DAMAGED IMPROVEMENTS TO ORIGINAL CONDITION AS ACCEPTABLE TO PARTIES HAVING JURISDICTION.
- D. CONDUCT OPERATIONS TO ENSURE MINIMUM INTERFERENCE WITH OPERATIONS, STREETS, WALKS, AND OTHER ADJACENT FACILITIES. DO NOT CLOSE OR OBSTRUCT STREETS, WALKS. OR OTHER OCCUPIED OR USED FACILITIES WITHOUT PERMISSION FROM AUTHORITIES HAVING JURISDICTION. STREETS AND ROADWAYS SHALL BE THOROUGHLY CLEANED AND/OR SWEPT ON A DAILY BASIS OR MORE FREQUENTLY AS REQUIRED BY THE GOVERNING AUTHORITY.
- 2. UNLESS SPECIFIED OTHERWISE ALL MATERIALS AND WORKMANSHIP SHALL BE IN ACCORDANCE WITH THE MASSACHUSETTS DOT SPECIFICATIONS FOR HIGHWAYS AND BRIDGES
- 3. ALL SLOPES, UNLESS OTHERWISE SPECIFIED, SHALL BE LOAMED AND SEEDED FOR STABILIZATION AS SOON AS POSSIBLE TO PREVENT EROSION INTO WETLAND RESOURCE AREAS, ABUTTING PROPERTIES. OR PUBLIC WAYS. EROSION CONTROL BLANKETS ARE REQUIRED FOR ALL 2H:1V SLOPES. SLOPES MAY NOT EXCEED 2H:1V
- ANY DEVIATIONS, I.E. "FIELD CHANGES" FROM THE DESIGN PLAN(S) MUST BE APPROVED BY THE DESIGN ENGINEER IN WRITING. CONTRACTOR SHOULD BE AWARE THAT LOCAL AND STATE AUTHORITIES HAVE JURISDICTION AND APPROVALS MUST BE OBTAINED FROM THE APPROPRIATE AUTHORITY PRIOR TO THE IMPLEMENTATION OF THE "FIELD CHANGE." CHA, INC. ASSUMES NO LIABILITY OR RESPONSIBILITY FOR WORK ASSOCIATED WITH FIELD CHANGES COMPLETED WITHOUT REGARD TO THE "FIELD CHANGE" PROCEDURE.
- 5. RELOCATION OF ANY UTILITIES SHALL BE PERFORMED IN ACCORDANCE WITH THE PROVISIONS OF THE APPROPRIATE UTILITY COMPANY AND/OR REGULATORY AGENCY.
- 6. *** DIG SAFE NOTE *** IN ACCORDANCE WITH MGL. CH. 82, SEC. 40 INCLUDING AMENDMENTS, ALL CONTRACTORS SHALL NOTIFY UTILITY COMPANIES AND GOVERNMENT AGENCIES, IN WRITING, OF THE INTENT TO EXCAVATE, BLAST, DEMOLISH, BORE, OR PERFORM OTHER EARTH MOVING OPERATIONS NO LESS THAN 72 HOURS AND NO MORE THAN 30 DAYS PRIOR TO THE COMMENCEMENT OF SUCH WORK (EXCLUSIVE OF SATURDAYS, SUNDAYS, AND LEGAL HOLIDAYS) OR CALL "DIG SAFE" AT 1-888-DIG-SAFE.
- 7. ADDITIONAL BENCHMARKS TO BE SET BY CONTRACTOR PRIOR TO CONSTRUCTION TO ENSURE QUALITY WORKMANSHIP.
- ANY STILLING AND/OR DETENTION BASINS SHOULD RECEIVE PERIODIC MAINTENANCE DURING CONSTRUCTION TO REMOVE DEPOSITED SILTS AND DEBRIS TO ENSURE PROPERTY DRAINAGE AND SETTLING OF PARTICULATE MATTER.
- 9. ALL MANHOLE COVERS FOR CROSS-COUNTRY LOCATIONS OR IN PUBLIC GATHERING LOCATIONS SHALL BE FITTED WITH BOLT LOCKS OR EQUIVALENT.
- 10. UNLESS OTHERWISE LABELED, ALL REINFORCED CONCRETE PIPE, RCP, SHALL BE CLASS V; ALL DUCTILE IRON PIPE SHALL BE CEMENT LINED CLASS 52; ALL PVC SEWER SHALL BE SDR 35. ALL HDPE PIPE TO BE HDPE STORM (WATERTIGHT JOINTS).

SITE DEMOLITION, EROSION & SEDIMENTATION CONTROL

1. ALL TEMPORARY STOCKPILE AREAS SHALL HAVE EROSION CONTROLS (HAYBALES AND SILT FENCE) AROUND THE PERIMETER.

RESIDUE, PAINTS, SOLVENTS, GREASE, FUEL, AND LUBE OIL, PESTICIDES, ANY SOLID WASTE MATERIALS.

- 2. UNDERGROUND UTILITIES MAY EXIST THAT ARE NOT SHOWN ON THIS PLAN. DIG SAFE MUST BE NOTIFIED (1-800-344-7233) AT LEAST 72 HOURS PRIOR TO ANY CONSTRUCTION.
- ALL SEDIMENTATION AND EROSION CONTROL MEASURES SHALL BE MAINTAINED THROUGHOUT THE CONSTRUCTION PERIOD. SEDIMENTATION AND EROSION CONTROL MEASURES SHALL BE IN PLACE AND OBSERVED PRIOR TO ANY WORK STARTING ON THE PROJECT.
- 4. SITE ENTRY AND EXIT LOCATIONS SHALL BE MAINTAINED IN A CONDITION WHICH WILL PREVENT TRACKING OR FLOWING OF SEDIMENT ONTO PUBLIC ROADWAYS. ALL SEDIMENT SPILLED, DROPPED, WASHED OR TRACKED ON A PUBLIC ROADWAY MUST BE REMOVED IMMEDIATELY. WHEN WASHING IS REQUIRED TO REMOVE SEDIMENT PRIOR TO ENTRANCE TO A PUBLIC ROADWAY, IT SHALL BE DONE ON AN AREA STABILIZED WITH CRUSHED STONE WHICH DRAINS INTO AN APPROVED SEDIMENT BASIN. ALL FINES IMPOSED FOR TRACKING ONTO PUBLIC ROADS SHALL BE PAID BY THE CONTRACTOR.
- 5. TEMPORARY SEEDING OR OTHER METHOD OF STABILIZATION SHALL BE INITIATED WITHIN 14 DAYS OF THE LAST DISTURBANCE ON ANY AREA OF THE SITE, UNLESS ADDITIONAL CONSTRUCTION OF THE AREAS IS EXPECTED WITHIN 21 DAYS OF THE LAST DISTURBANCE.
- 6. UPON COMPLETION OF FINE GRADING, ALL AREAS NOT OTHERWISE PERMANENTLY STABILIZED SHALL BE SEEDED AND MAINTAINED UNTIL A UNIFORM COVERAGE OF 75%± MINIMUM DENSITY, AS DETERMINED BY THE OWNER'S REPRESENTATIVE, IS ACHIEVED.
- MAINTENANCE EROSION CONTROLS SHALL BE REPAIRED OR REPLACED AS INSPECTION DEEMS NECESSARY OR AS DIRECTED BY THE ENGINEER OR ARCHITECT. ACCUMULATED SILT AT ANY EROSION CONTROL DEVICE SHALL BE REMOVED WHEN IT REACHES A DEPTH OF 6", AND SHALL BE DISTRIBUTED ON-SITE IN A MANNER NOT CONTRIBUTING TO ADDITIONAL SILTATION.
- ANY CONTRACTOR IS RESPONSIBLE FOR REESTABLISHING ANY EROSION CONTROL DEVICE WHICH HE DISTURBS. EACH CONTRACTOR SHALL NOTIFY THE ENGINEER/ARCHITECT OF ANY DEFICIENCIES IN THE ESTABLISHED EROSION CONTROL MEASURES WHICH MAY LEAD TO UNAUTHORIZED DISCHARGE OR STORM WATER POLLUTION. SEDIMENTATION OR OTHER POLLUTANTS. UNAUTHORIZED POLLUTANTS INCLUDE, BUT ARE NOT LIMITED TO, EXCESS CONCRETE DUMPING OR CONCRETE
- 9. ALL SIDE SLOPES SHALL BE SEEDED WITH GRASS OR INSTALL JUTE NETTING TO PREVENT EROSION. SIDE SLOPES ALONG THE PERIMETER OF THE DEVELOPED AREA SHALL BE STABILIZED IMMEDIATELY FOLLOWING CONSTRUCTION.
- MAINTENANCE: EROSION CONTROLS SHALL BE REPAIRED OR REPLACED AS INSPECTION DEEMS NECESSARY OR AS DIRECTED BY THE ENGINEER OR ARCHITECT. ACCUMULATED SILT AT ANY EROSION CONTROL DEVICE SHALL BE REMOVED WHEN IT REACHES A DEPTH OF 6", AND SHALL BE DISTRIBUTED ON-SITE IN A MANNER NOT CONTRIBUTING TO ADDITIONAL SILTATION.
- SPECTIONS: INSPECTIONS ARE TO BE PERFORMED BY QUALIFIED PERSONNEL. DISTURBED AREAS THAT HAVE NOT BEEN FINALLY STABILIZED. AREAS USED FOR STORAGE. TRUCTURAL CONTROL MEASURES, AND LOCATIONS WHERE VEHICLES ENTER OR EXIT THE SITE, MUST BE INSPECTED ONCE EVERY 7 DAYS AND WITHIN 24 HOURS OF A STORM EVEN OF 0.5 INCHES OR GREATER. STABILIZED AREAS ARE TO BE INSPECTED ONCE PER MONTH DISTURBED AREAS AND STORAGE AREAS EXPOSED TO PRECIPITATION SHALL BE INSPECTED FOR EVIDENCE OF OR POTENTIAL FOR POLLUTANTS ENTERING THE DRAINAGE SYSTEM. CONTROL MEASURES SHALL BE OBSERVED TO ENSURE THEY ARE WORKING PROPERLY. DISCHARGE LOCATIONS AND POINTS SHALL BE INSPECTED TO ASCERTAIN WHETHER CONTROLS ARE PREVENTING SIGNIFICANT IMPACT. BASED ON THE RESULTS OF THE ABOVE INSPECTIONS, ANY NECESSARY CHANGES TO THE PLAN WILL BE MADE WITHIN 7 DAYS OF THE INSPECTION. THE CHANGES MUST BE IMPLEMENTED IN THE FIELD BEFORE THE NEXT STORM EVEN IF PRACTICABLE, OTHERWISE AS SOON AS POSSIBLE.
- 12. INSTALL AND MAINTAIN CATCH BASIN INSERTS IN ALL PROPOSED CATCH BASINS.
- 13. PROVIDE TEMPORARY SEDIMENTATION BASINS, FILTER SOCKS, ETC. AS NECESSARY.
- 14. STOCKPILES ARE TO BE AT LEAST 50 FEET FROM WETLAND AREAS. STOCKPILES NOT TO BE REUSED WITHIN 30 DAYS ARE TO BE STABILIZED WITH SEED OR MULCH.
- 15. POTENTIAL STOCK PILE AREA TO BE PROTECTED WITH EROSION CONTROL MEASURES.
- 16. THE CONTRACTOR SHALL HAVE A WATER TRUCK ON-SITE AT ALL TIMES AND SHALL PROVIDE TEMPORARY PLANTINGS OR OTHER COVERINGS SUCH AS WOOD CHIPS TO MINIMIZE THE AMOUNT OF DUST I FAVING THE PREMISES.
- 17. SUBJECT TO ORDER OF CONDITIONS BY HINGHAM CONSERVATION COMMISSION.
- 18. LOCATIONS OF THE SUBSURFACE RECHARGE SYSTEMS TO BE PROTECTED DURING CONSTRUCTION TO AVOID COMPACTION.

SITE WORK

CAUTION - NOTICE TO CONTRACTOR

THE CONTRACTOR IS SPECIFICALLY CAUTIONED THAT THE LOCATION AND/OR ELEVATION OF EXISTING UTILITIES AS SHOWN ON THESE PLANS IS BASED ON DESIGN PLANS AND LIMITED AS-BUILT INFORMATION. THE INFORMATION IS NOT TO BE RELIED ON AS BEING EXACT OR COMPLETE. THE CONTRACTOR MUST CALL THE APPROPRIATE UTILITY COMPANIES AT LEAST 72 HOURS (EXCLUSIVE OF SATURDAYS, SUNDAYS, AND LEGAL HOLIDAYS) PRIOR TO ANY EXCAVATION BLASTING, DEMOLITION, BORING, OR OTHER EARTH MOVING OPERATIONS TO REQUEST EXACT FIELD LOCATIONS OF UTILITIES. IT SHALL BE THE RESPONSIBILITY OF THE CONTRACTOR TO RELOCATE ALL EXISTING UTILITIES WHICH CONFLICT WITH THE PROPOSED IMPROVEMENTS AT NO ADDITIONAL EXPENSE TO OWNER.

- 2. FILL MATERIAL
- A. ENSURE THAT AREAS TO BE FILLED ARE FREE OF STANDING WATER, FROST, FROZEN MATERIAL, TRASH, AND DEBRIS PRIOR TO FILL PLACEMENT.
- B. PLACE APPROPRIATE FILL MATERIAL AS DESIGNATED BY THE GEOTECHNICAL ENGINEER IN HORIZONTAL LAYERS NOT EXCEEDING EIGHT INCHES (8") IN LOOSE DEPTH AND COMPACT EACH LAYER AT OPTIMUM MOISTURE CONTENT TO THE GREATER OF:
- B.1. ADJACENT UNDISTURBED SOIL, OR
- B.2. 95% OF THE MAXIMUM DRY DENSITY OF THE EMBANKMENT MATERIAL AS DETERMINED BY AASHTO STANDARD METHOD T99, METHOD C.
- FINISH GRADING
- A. GRADE ALL AREAS WHERE FINISH GRADE ELEVATIONS ARE INDICATED ON DRAWINGS, OTHER THAN PAVED AREAS AND BUILDINGS, INCLUDING EXCAVATED AREAS, FILLED AND TRANSITION AREAS, AND LANDSCAPED AREAS. GRADED AREAS SHALL BE UNIFORM AND SMOOTH, FREE FROM DEBRIS, OR IRREGULAR SURFACE CHANGES. FINISHED SUBGRADE SURFACE SHALL NOT BE MORE THAN 0.10 FEET ABOVE OR BELOW ESTABLISHED SUBGRADE ELEVATIONS. AND ALL GROUND SURFACES SHALL VARY UNIFORMLY BETWEEN INDICATED ELEVATIONS. FINISH DITCHES SHALL BE GRADED TO ALLOW FOR PROPER DRAINAGE WITHOUT PONDING AND IN A MANNER THAT WILL MINIMIZE EROSION POTENTIAL
- B. GRADE SURFACE TO MATCH ADJACENT GRADES AND TO PROVIDE FLOW TO SURFACE DRAINAGE STRUCTURES, OR GRADE AS DESIGNATED ON THE PLANS AFTER FILL PLACEMENT
- THE CONTRACTOR IS RESPONSIBLE FOR GENERAL CLEANUP OF THE PROJECT ON A DAILY BASIS AND AT THE COMPLETION OF THE PROJECT. OPEN TRENCHES, DITCHES, EXCAVATIONS, ETC. SHALL NOT BE PERMITTED TO BE LEFT OPEN OVERNIGHT. CONTRACTOR WILL BACKFILL OR UTILIZE SUITABLE STEEL PLATES FOR THE SECURING OF THE PROJECT SITE PRIOR TO CEASING WORK EACH DAY.
- APPROPRIATE TRAFFIC CONTROL, I.E. SIGNAGE, BARRICADES, AND OTHER MEANS, WILL BE SUPPLIED BY THE CONTRACTOR IN ACCORDANCE WITH ALL FEDERAL, STATE AND LOCAL
- UNDER NO CIRCUMSTANCES MAY ANY UTILITY, STRUCTURE, AND/OR REPAIR BE BACKFILLED UNLESS INSPECTED AND APPROVED BY THE TOWN OFFICIALS AND/OR REPRESENTATIVE. RECEIPT OF APPROVAL TO BACKFILL WILL NOT RELEASE THE CONTRACTOR FROM ANY RESPONSIBILITY OR LIABILITY FOR PERFORMANCE TESTS REQUIRED AS PART OF THIS PROJECT
- PROPER SHORING AND TRENCH BOXES SHALL BE UTILIZED AS REQUIRED BY LOCAL, STATE, AND FEDERAL REGULATORY AGENCIES TO PROVIDE A SAFE WORKING ENVIRONMENT. SHORING SHALL BE DESIGNED BY A PROFESSIONAL ENGINEER LICENSED IN THE STATE OF MASSACHUSETTS WITH EXPERIENCE IN SHORING DESIGN.
- 8. ALL UTILITIES DISTURBED DURING CONSTRUCTION SHALL BE REPAIRED BY THE CONTRACTOR IN ACCORDANCE WITH THE APPLICABLE UTILITY PURVEYOR AT NO ADDITIONAL COST TO THE OWNER.
- A. ALL WATER PIPING, VALVES, HYDRANTS, AND FITTINGS ETC. TO CONFORM TO LOCAL GUIDELINES OR AS DIRECTED BY THE WATER DEPARTMENT. CONSTRUCTION OF WATER LINE
- ALL WATER PIPE SHALL BE THICKNESS CLASS 52 DUCTILE IRON. ALL PIPES AND FITTINGS SHALL HAVE A CEMENT LINING TWICE THE THICKNESS SPECIFIED IN AWWA C104 AND SHALL HAVE A BITUMINOUS SEAL COAT APPLIES INSIDE AND OUTSIDE CONFORMING TO AWWA C104, "TYTON" OR MECHANICAL JOINTS ARE PERMITTED UNLESS OTHERWISE
- C. REFER TO PLUMBING PLANS FOR WATER SERVICE, FIRE PROTECTION, AND SANITARY SEWER CONNECTIONS UNLESS OTHERWISE NOTED.
- 10. CONTRACTOR SHALL OBTAIN APPROVAL FOR ALL FIRE DEPARTMENT CONNECTIONS FROM THE FIRE DEPARTMENT PRIOR TO CONSTRUCTION

WATER TESTING

- 1. THESE NOTES ARE INTENDED TO SUPPLEMENT THE LOCAL REQUIREMENTS FOR MATERIALS AND WORKMANSHIP.
- 2. REQUIRED TESTS FOR WATERLINES AND FORCE MAINS:
- A. PERFORM THE FOLLOWING AFTER THE PIPE HAS BEEN INSTALLED AND PRIOR TO FINAL ACCEPTANCE:
- A.1. PRESSURE TEST. / A.2. LEAKAGE TEST.
- 3. PRESUMPTIVE HYDROSTATIC TESTS MAY BE PERFORMED WHEN THE SYSTEM IS PARTIALLY BACKFILLED TO "CHECK" THE WORK, BUT FINAL ACCEPTANCE SHALL BE BASED ON HYDROSTATIC TESTS PERFORMED ON THE FINISHED SYSTEM AFTER IT IS COMPLETELY BACKFILLED.
- PRESSURE TEST
 - A. TEST PIPING TO 1.5 TIMES THE PIPE WORKING PRESSURE, OR 150 PSI, WHICHEVER IS GREATER. MEASURE TEST PRESSURES AT THE LOWEST POINT IN THE PIPE SECTION AND CORRECT TO THE ELEVATION OF THE GAUGE.
 - B. RELIEVE TRAPPED AIR AT THE SECTION HIGH POINTS THROUGH HYDRANTS. OR TAPS INSTALLED FOR THIS PURPOSE, PROVIDED TEMPORARY INSTALLATIONS ARE REMOVED AND PLUGGED AFTER ACCEPTANCE.
 - C. MAINTAIN THE TEST PRESSURE FOR A PERIOD OF TWO (2) HOURS. AT THE END OF THE TEST PERIOD, IF THE TEST PRESSURE REMAINS CONSTANT, THE PIPE SECTION SHALL HAVE PASSED THE TEST. IF THE PRESSURE HAS DROPPED, IT SHALL BE BROUGHT BACK TO THE TEST PRESSURE BY PUMPING A KNOWN VOLUME OF WATER (BY PUMPING FROM A GRADUATED CONTAINER OR BY METERING) BACK INTO THE PIPE. THE VOLUME OF WATER THUS USED, REPRESENTING LEAKAGE FROM THE PIPE, SHALL BE RECORDED. IF THE LEAKAGE IS LESS THAN THE ALLOWABLE LEAKAGE SPECIFIED BELOW. THE PIPE SHALL HAVE PASSED THE TEST. IF THE LEAKAGE EXCEEDS THE ALLOWABLE LEAKAGE SPECIFIED, THE CONTRACTOR SHALL LOCATE THE LEAK, PERMANENTLY REPAIR THE SECTION OF PIPE WHERE THE LEAK IS OCCURRING TO THE SATISFACTION OF THE ENGINEER, AND RETEST THE PIPE
- LEAKAGE TEST:
- A. CONDUCT THE LEAKAGE TEST CONCURRENTLY WITH THE PRESSURE TEST.

LOCATE, REPAIR AND RETEST UNTIL THE LEAKAGE IS WITHIN THE LIMITS SPECIFIED.

- B. THE MAXIMUM ALLOWED LEAKAGE IS DETERMINED BY THE FOLLOWING FORMULA:
 - $L = N \times D \times P_{1/2}$ WHERE L = ALLOWABLE LEAKAGE, IN GPH; WHERE N = NO. OF JOINTS IN TEST SECTION WHERE D = NOMINAL PIPE DIAMETER, IN INCHES ; WHERE P = AVERAGE TEST PRESSURE, IN PSIG
- 5. ACCEPTANCE SHALL BE DETERMINED ON THE BASIS OF ALLOWABLE LEAKAGE. IF ANY PIPE SECTION DISCLOSES LEAKAGE GREATER THAN THAT SPECIFIED,
- 6. MAKE ALL VISIBLE LEAKS TIGHT REGARDLESS OF THE AMOUNT OF LEAKAGE, AND IF THE LINES DO NOT MEET THE ABOVE LEAKAGE TEST, REPAIR AND RETEST AS NECESSARY UNTIL THE LEAKAGE REQUIREMENT IS MET. REPAIR OR REPLACE ALL DEFECTIVE WORK.

DISINFECTION OF POTABLE WATER MAINS

- 1. DISINFECT ALL POTABLE WATER MAINS IN ACCORDANCE WITH THE LATEST VERSION OF AWWA C651, EXCEPT THAT THE PLACEMENT OF CHLORINE POWDER OR TABLETS INSIDE THE PIPE DURING INSTALLATION SHALL NOT BE ALLOWED. DISINFECT WATER MAINS AFTER THE PIPING HAS PASSED THE PRESSURE AND LEAKAGE TESTING.
- 2. FLUSH THE PIPE WITH WATER AT A MINIMUM VELOCITY OF 2.5 FEET PER SECOND (FPS) TO CLEAR ALL FOREIGN MATERIAL FROM THE PIPE.
- 3. APPLY A CHLORINE SOLUTION WITH A CONCENTRATION BETWEEN 50 PARTS PER MILLION (PPM) AND 100 PPM. THE CHLORINE SOLUTION SHALL REMAIN IN THE PIPING FOR A MINIMUM OF 24 HOURS. THE CONCENTRATION AT THE END OF THIS PERIOD SHALL BE AT LEAST 25 PPM IN ALL SECTIONS OF THE MAIN. REPEAT THE ENTIRE PROCEDURE IF THE RESIDUAL IS LESS THAN 25 PPM.
- A. WHILE THE CHLORINATED WATER IS BEING ADDED, ALL APPURTENANCES (VALVES, HYDRANTS, ETC.) SHALL BE OPERATED SO AS TO COMPLETELY DISINFECT THE NEW WORK.
- B. POSITION VALVES SO THAT THE CHLORINE SOLUTION IN THE SECTION BEING DISINFECTED WILL NOT FLOW INTO WATER MAINS IN ACTIVE SERVICE.
- C. CHLORINE RESIDUAL SAMPLES SHALL BE TAKEN AS DIRECTED BY THE ENGINEER.
- 4. AFTER THE TWENTY FOUR (24) HOUR RETENTION PERIOD, FLUSH THE MAIN UNTIL RESIDUAL TESTING INDICATES THAT THE CHLORINE CONCENTRATION IS
- APPROXIMATELY THAT OF THE NEIGHBORING SERVICE AREA.
- A. DISPOSE OF HEAVILY CHLORINATED WATER INTO SANITARY SEWER OR TANK TRUCK. B. THE OWNER AND THE OWNER OF THE SANITARY SEWER SYSTEM SHALL BE NOTIFIED A MINIMUM OF TWENTY-FOUR (24) HOURS PRIOR TO THE DISCHARGE OF ANY WATER TO THE SANITARY SEWER. CONTRACTOR SHALL SUBMIT TO THE ENGINEER WRITTEN CONFIRMATION THAT THE OWNER OF SANITARY SEWER SYSTEM HAS APPROVED THE DISCHARGE OF WATER TO ITS SANITARY SEWER.
- C. UNDER NO CIRCUMSTANCES WILL THE EMPTYING OF WATER ONTO ROADWAYS, OR INTO DITCHES, CULVERTS, STREAMS OR WETLANDS BE ALLOWED. 5. AFTER DISINFECTION AND FINAL FLUSHING, AND PRIOR TO PLACING THE LINES IN SERVICE, THE CONTRACTOR SHALL COLLECT BACTERIOLOGICAL SAMPLES (BOTH COLIFORM AND HETEROTROPHIC PLATE COUNT) AND SUBMIT SAMPLES TO AN APPROVED TESTING LABORATORY. TWO CONSECUTIVE SETS OF SAMPLES SHALL BE TAKEN AT LEAST 24 HOURS APART IN ACCORDANCE WITH AWWA C651. THE COLLECTION POINTS SHALL BE AS DIRECTED BY THE
- A. THE TESTING LABORATORY PERFORMING THE BACTERIOLOGICAL ANALYSIS SHALL BE ACCEPTABLE TO THE ENGINEER.
- B. SUBMIT THREE (3) COPIES OF THE LABORATORY ANALYSIS TO THE ENGINEER.
- A. SHOULD SAFE RESULTS NOT OCCUR AFTER LABORATORY TESTS, THE CONTRACTOR SHALL, AT HIS EXPENSE, REPEAT THE DISINFECTION PROCEDURE UNTIL SAFE RESULTS ARE OBTAINED. THIS INCLUDES A POSITIVE RESULT FOR COLIFORM OR A MEASURED HETEROTROPHIC PLATE COUNT OF GREATER THAN 500 COLONY-FORMING UNITS PER ML.
- B. CONTRACTOR SHALL PAY FOR ALL TESTING REQUIRED.

ENGINEER AND LOCAL AUTHORITY HAVING JURISDICTION.

- 6. ALL PRECAUTION SHALL BE TAKEN TO MAINTAIN DRY AND SANITARY CONDITIONS AND PREVENT CONTAMINATION OF ANY PIPING. IF, IN THE OPINION OF THE ENGINEER, CONTAMINATION HAS OCCURRED, THE CONTRACTOR SHALL REPEAT THE DISINFECTION PROCEDURE AND TESTING AT HIS COST AND EXPENSE.
- 7. ALL TESTING SHALL CONFORM TO THE TOWN, DPW, AND WEIR RIVER WATER SYSTEM REQUIREMENTS.

LEGEND - EXISTING

	LOCUS PROPERTY LINE	ET	ELECTRIC TRANSFORMER
	RIGHT OF WAY LINE	EC	ELECTRIC CONDUIT
	ABUTTER LINE	EHH	ELECTRIC HAND HOLE
	LEASE LINE	ЕМ	ELECTRIC METER
——— 315 ———	MAJOR CONTOUR	O UPR	UTILITY POLE W/RISER
316	MINOR CONTOUR	}	GUY ANCHOR AND WIRE
OHW	OVERHEAD WIRE	*	LIGHT POLE
oCLF	CHAIN LINK FENCE (CLF)	ф	GROUND LIGHT
<i>WDF</i>	WOODEN FENCE (WDF)	(M)	MONITORING WELL
	UNDERGROUND WATER LINE		DECIDUOUS TREE
	UNDERGROUND DRAIN LINE		ARBORVITAE TREE
G	UNDERGROUND GAS LINE	DNE	DO NOT ENTER SIGN
E	UNDERGROUND ELECTRIC LINE	Š	IRRIGATION CONTROL VALVE
s	UNDERGROUND SEWER LINE	XWALK	PEDESTRIAN CROSSING
T	UNDERGROUND TELEPHONE LINE	FFE	FINISH FLOOR ELEVATION
× 31.0	SPOT ELEVATION	EOP	EDGE OF PAVEMENT
□ CTB	CATCH BASIN	CC	CONCRETE CURB
DMH	DRAIN MANHOLE	GC	GRANITE CURB
S SMH	SEWER MANHOLE	CWK	CONCRETE WALK
\bigcirc	TELEPHONE MANHOLE	CONC	CONCRETE
E	ELECTRIC MANHOLE	CRW	CONCRETE RETAINING WALL
GM	GAS METER	HRLM	METAL HANDRAIL
Y	WALL HYDRANT	ROH	ROOF OVERHANG
	HYDRANT	SYL	SINGLE YELLOW LINE
Ď	DOWN SPOUT	AG	ABOVE GROUND
⊠ ev	GAS GATE	□ SBDH/CBDH	STONE BOUND/CONC. BOUND
L Wv	WATER GATE	_ ,	w/DRILL HOLE


LEGEND - PROPOSED

----×----×---- CHAINLINK FENCE

585	MAJOR CONTOUR		STORM SEWER DRAIN BASIN
586	MINOR CONTOUR	0	STORM MANHOLE
	DOMESTIC WATER	+	HYDRANT ASSEMBLY
	FIRE PROTECTION	×	LINE VALVE
——————————————————————————————————————	UNDERGROUND ELECTRIC	@	POST INDICATOR VALVE
s	SANITARY SEWER	0	SANITARY MANHOLE
————FM————	FORCEMAIN		ELECTRIC MANHOLE
	STORM SEWER	● DH	DRILL HOLE
	BIORETENTION LIMIT LINE	■ CB/DH	CONCRETE BOUND w/DRILL HOL
—— —— GAS—— ——	NATURAL GAS		

OWNER/APPLICANT

HINGHAM, MA 02043

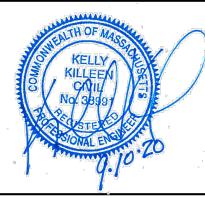

ENGINEER, ARCHITECT, LANDSCAPE ARCHITECT OR LAND SURVEYOR TO ALTER AN ITEM IN ANY WAY. IF AN ITEM BEARII


OF THE ALTERATION.

HINGHAM GAS

۱o.	Submittal / Revision	App'd.	Ву	Date
Α	PERMIT SET	KK	JM	5/1/2020
В	PERMIT SET	KK	JM	9/10/2020

NOTES & LEGEND

esigned By: DR/BN	Drawn By: DR/BN	Checked By: KK
ssue Date:	Project No:	Scale:
5/01/2020	060903	NONE

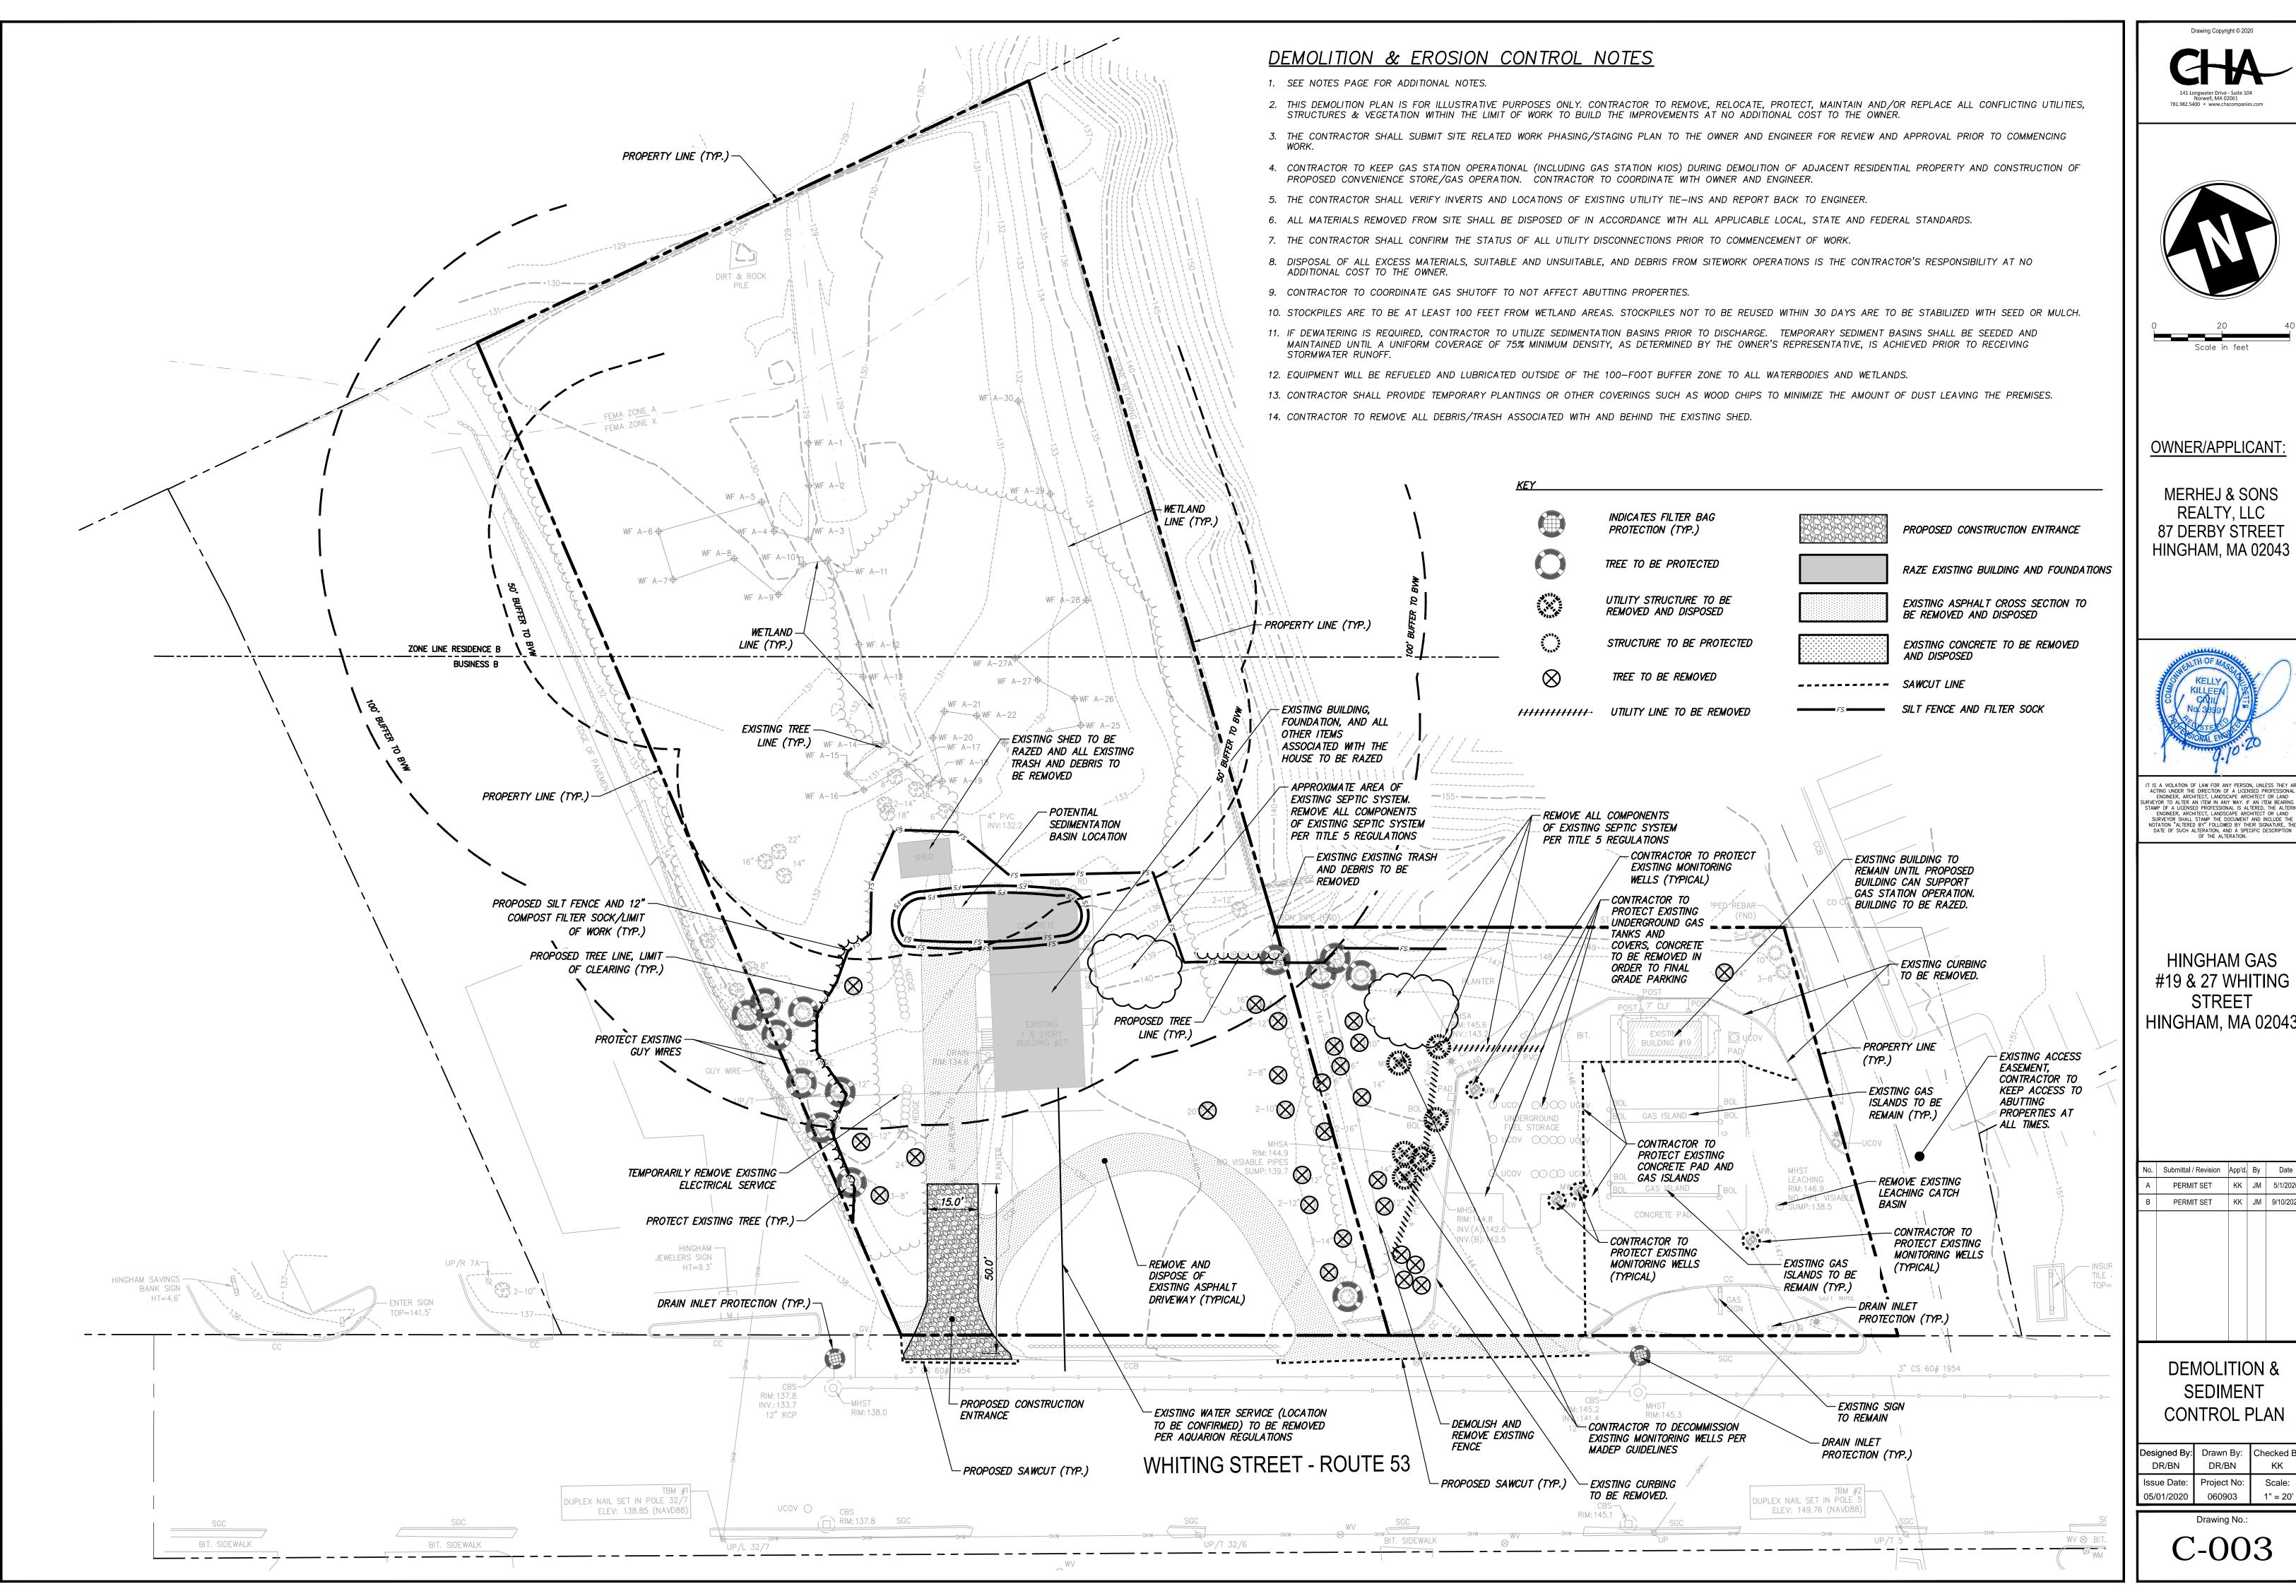





OWNER/APPLICANT:

MERHEJ & SONS REALTY, LLC **87 DERBY STREET** HINGHAM, MA 02043



ENGINEER, ARCHITECT, LANDSCAPE ARCHITECT OR LAND SURVEYOR TO ALTER AN ITEM IN ANY WAY. IF AN ITEM BEARIN OF THE ALTERATION.


HINGHAM GAS #19 & 27 WHITING STREET HINGHAM, MA 02043

PERMIT SET	KK	JM	5/1/2020
PERMIT SET	KK	JM	9/10/2020


DEMOLITION & SEDIMENT CONTROL PLAN

esigned By:	Drawn By:	Checked By:
DR/BN	DR/BN	KK
Issue Date:	Project No:	Scale:
05/01/2020	060903	1" = 20'

Drawing No.:

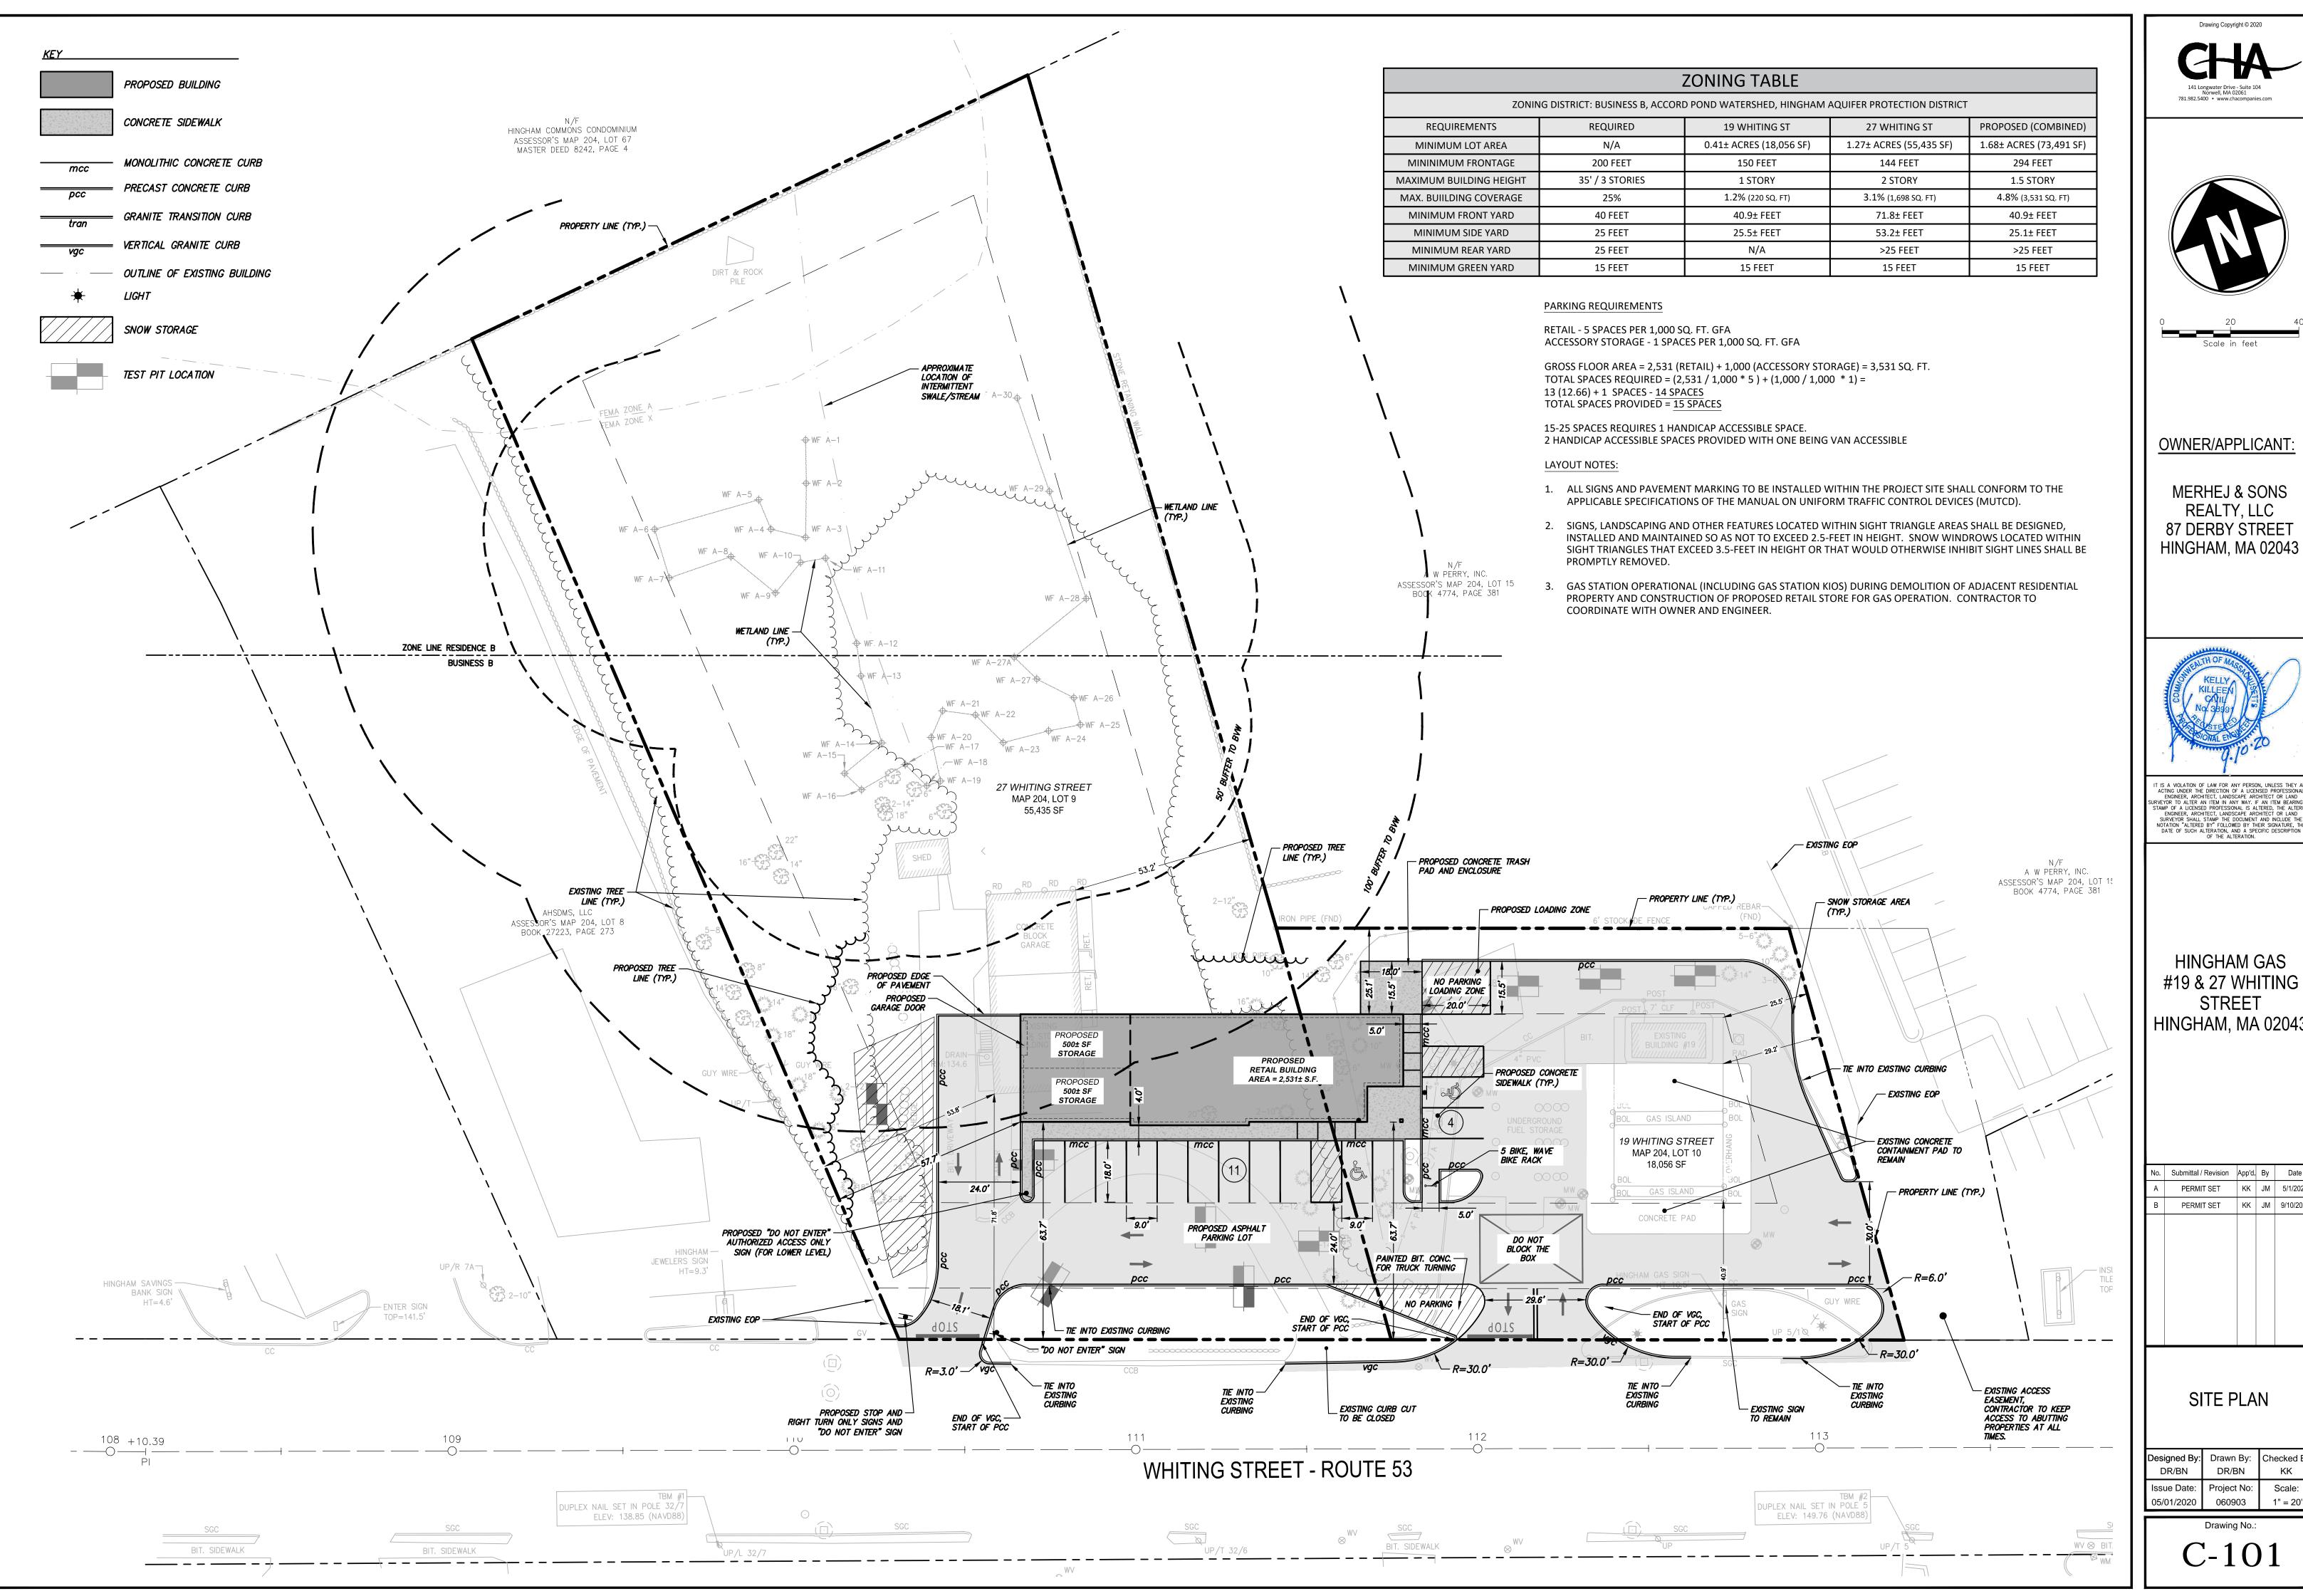




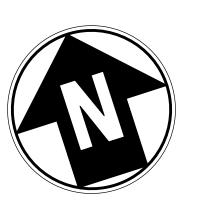

OWNER/APPLICANT:

MERHEJ & SONS REALTY, LLC **87 DERBY STREET** HINGHAM, MA 02043

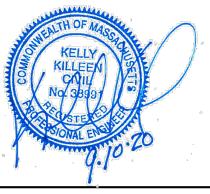

ACTING UNDER THE DIRECTION OF A LICENSED PROFESSIONAL ENGINEER, ARCHITECT, LANDSCAPE ARCHITECT, CA LAND SURVEYOR TO ALTER AN ITEM IN ANY WAY, IF AN ITEM BEARING STAMP OF A LICENSED PROFESSIONAL IS ALTERED, THE ALTERIN ENGINEER, ARCHITECT, LANDSCAPE ARCHITECT OR LAND SURVEYOR SHALL STAMP THE DOCUMENT AND INCLUDE THE NOTATION "ALTERED BY" FOLLOWED BY THEIR SIGNATURE, THE DATE OF SUCH ALTERATION, AND A SPECIFIC DESCRIPTION OF THE ALTERATION.


OF THE ALTERATION.

HINGHAM GAS #19 & 27 WHITING STREET HINGHAM, MA 02043

PERMIT SET	KK	JIVI	5/1/2020
PERMIT SET	KK	JM	9/10/2020

SITE PLAN

	Designed By:	Drawn By:	Checked By
	DR/BN	DR/BN	KK
	Issue Date:	Project No:	Scale:
	05/01/2020	060903	1" = 20'
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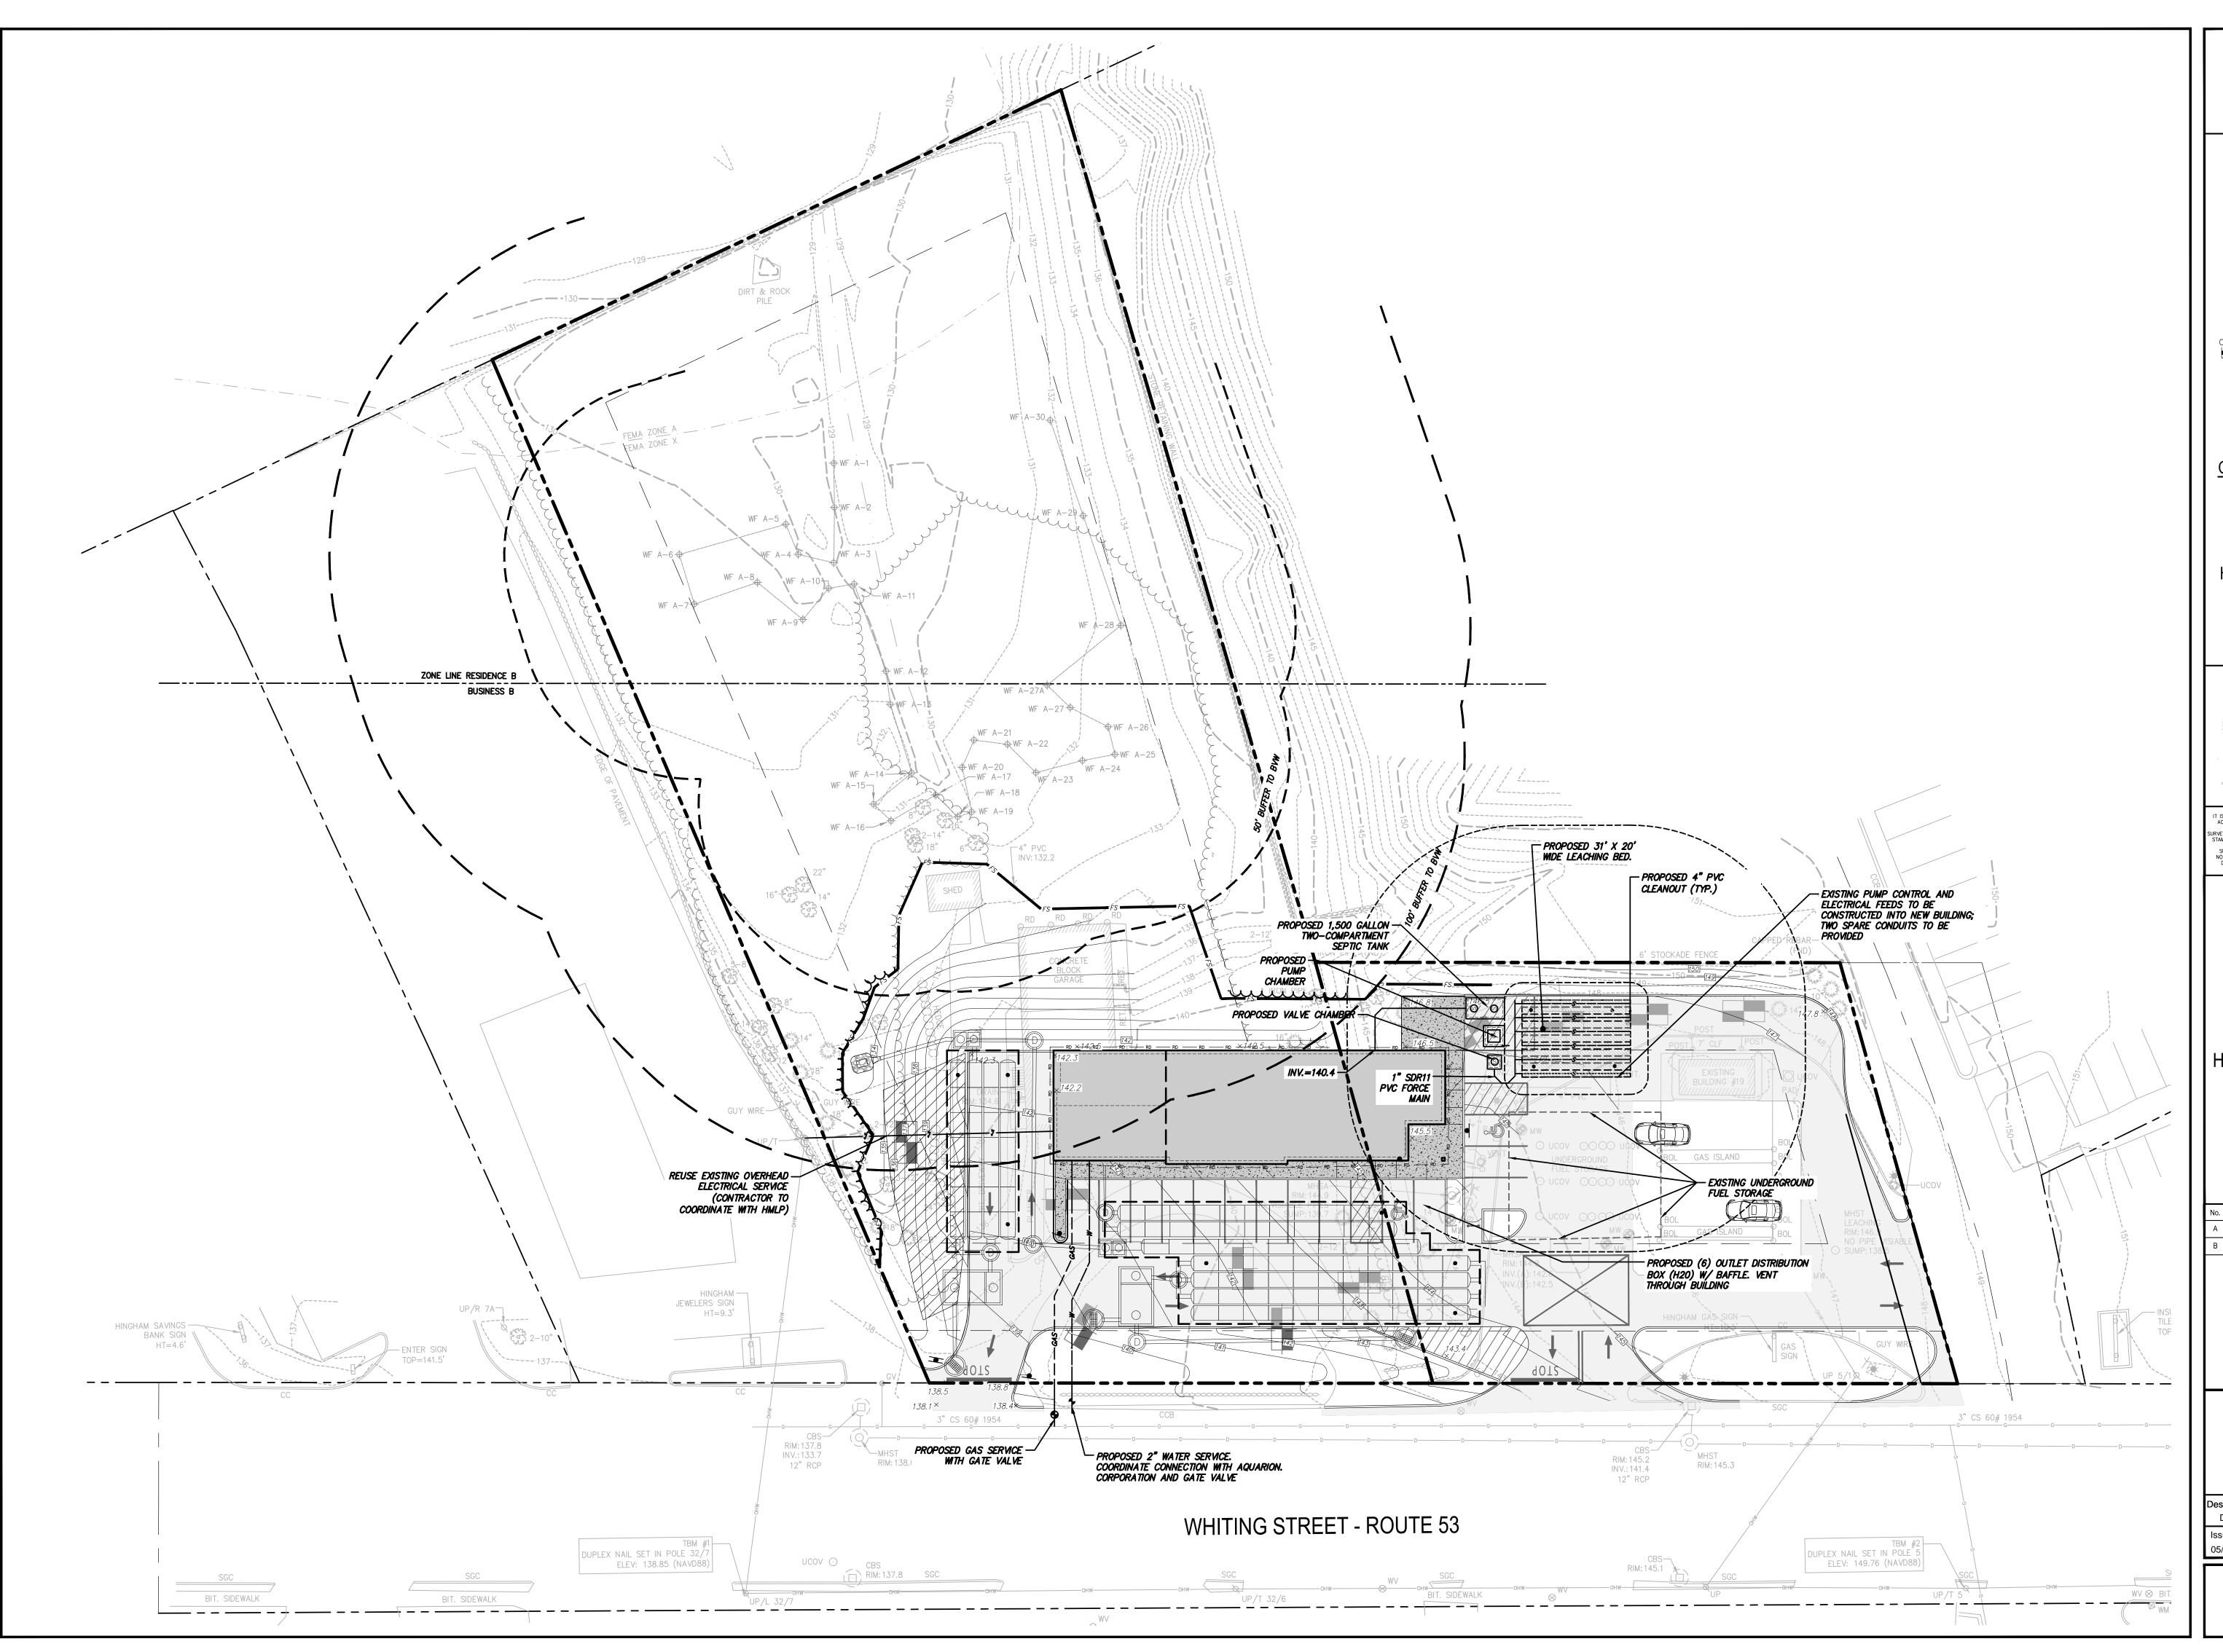
87 DERBY STREET HINGHAM, MA 02043

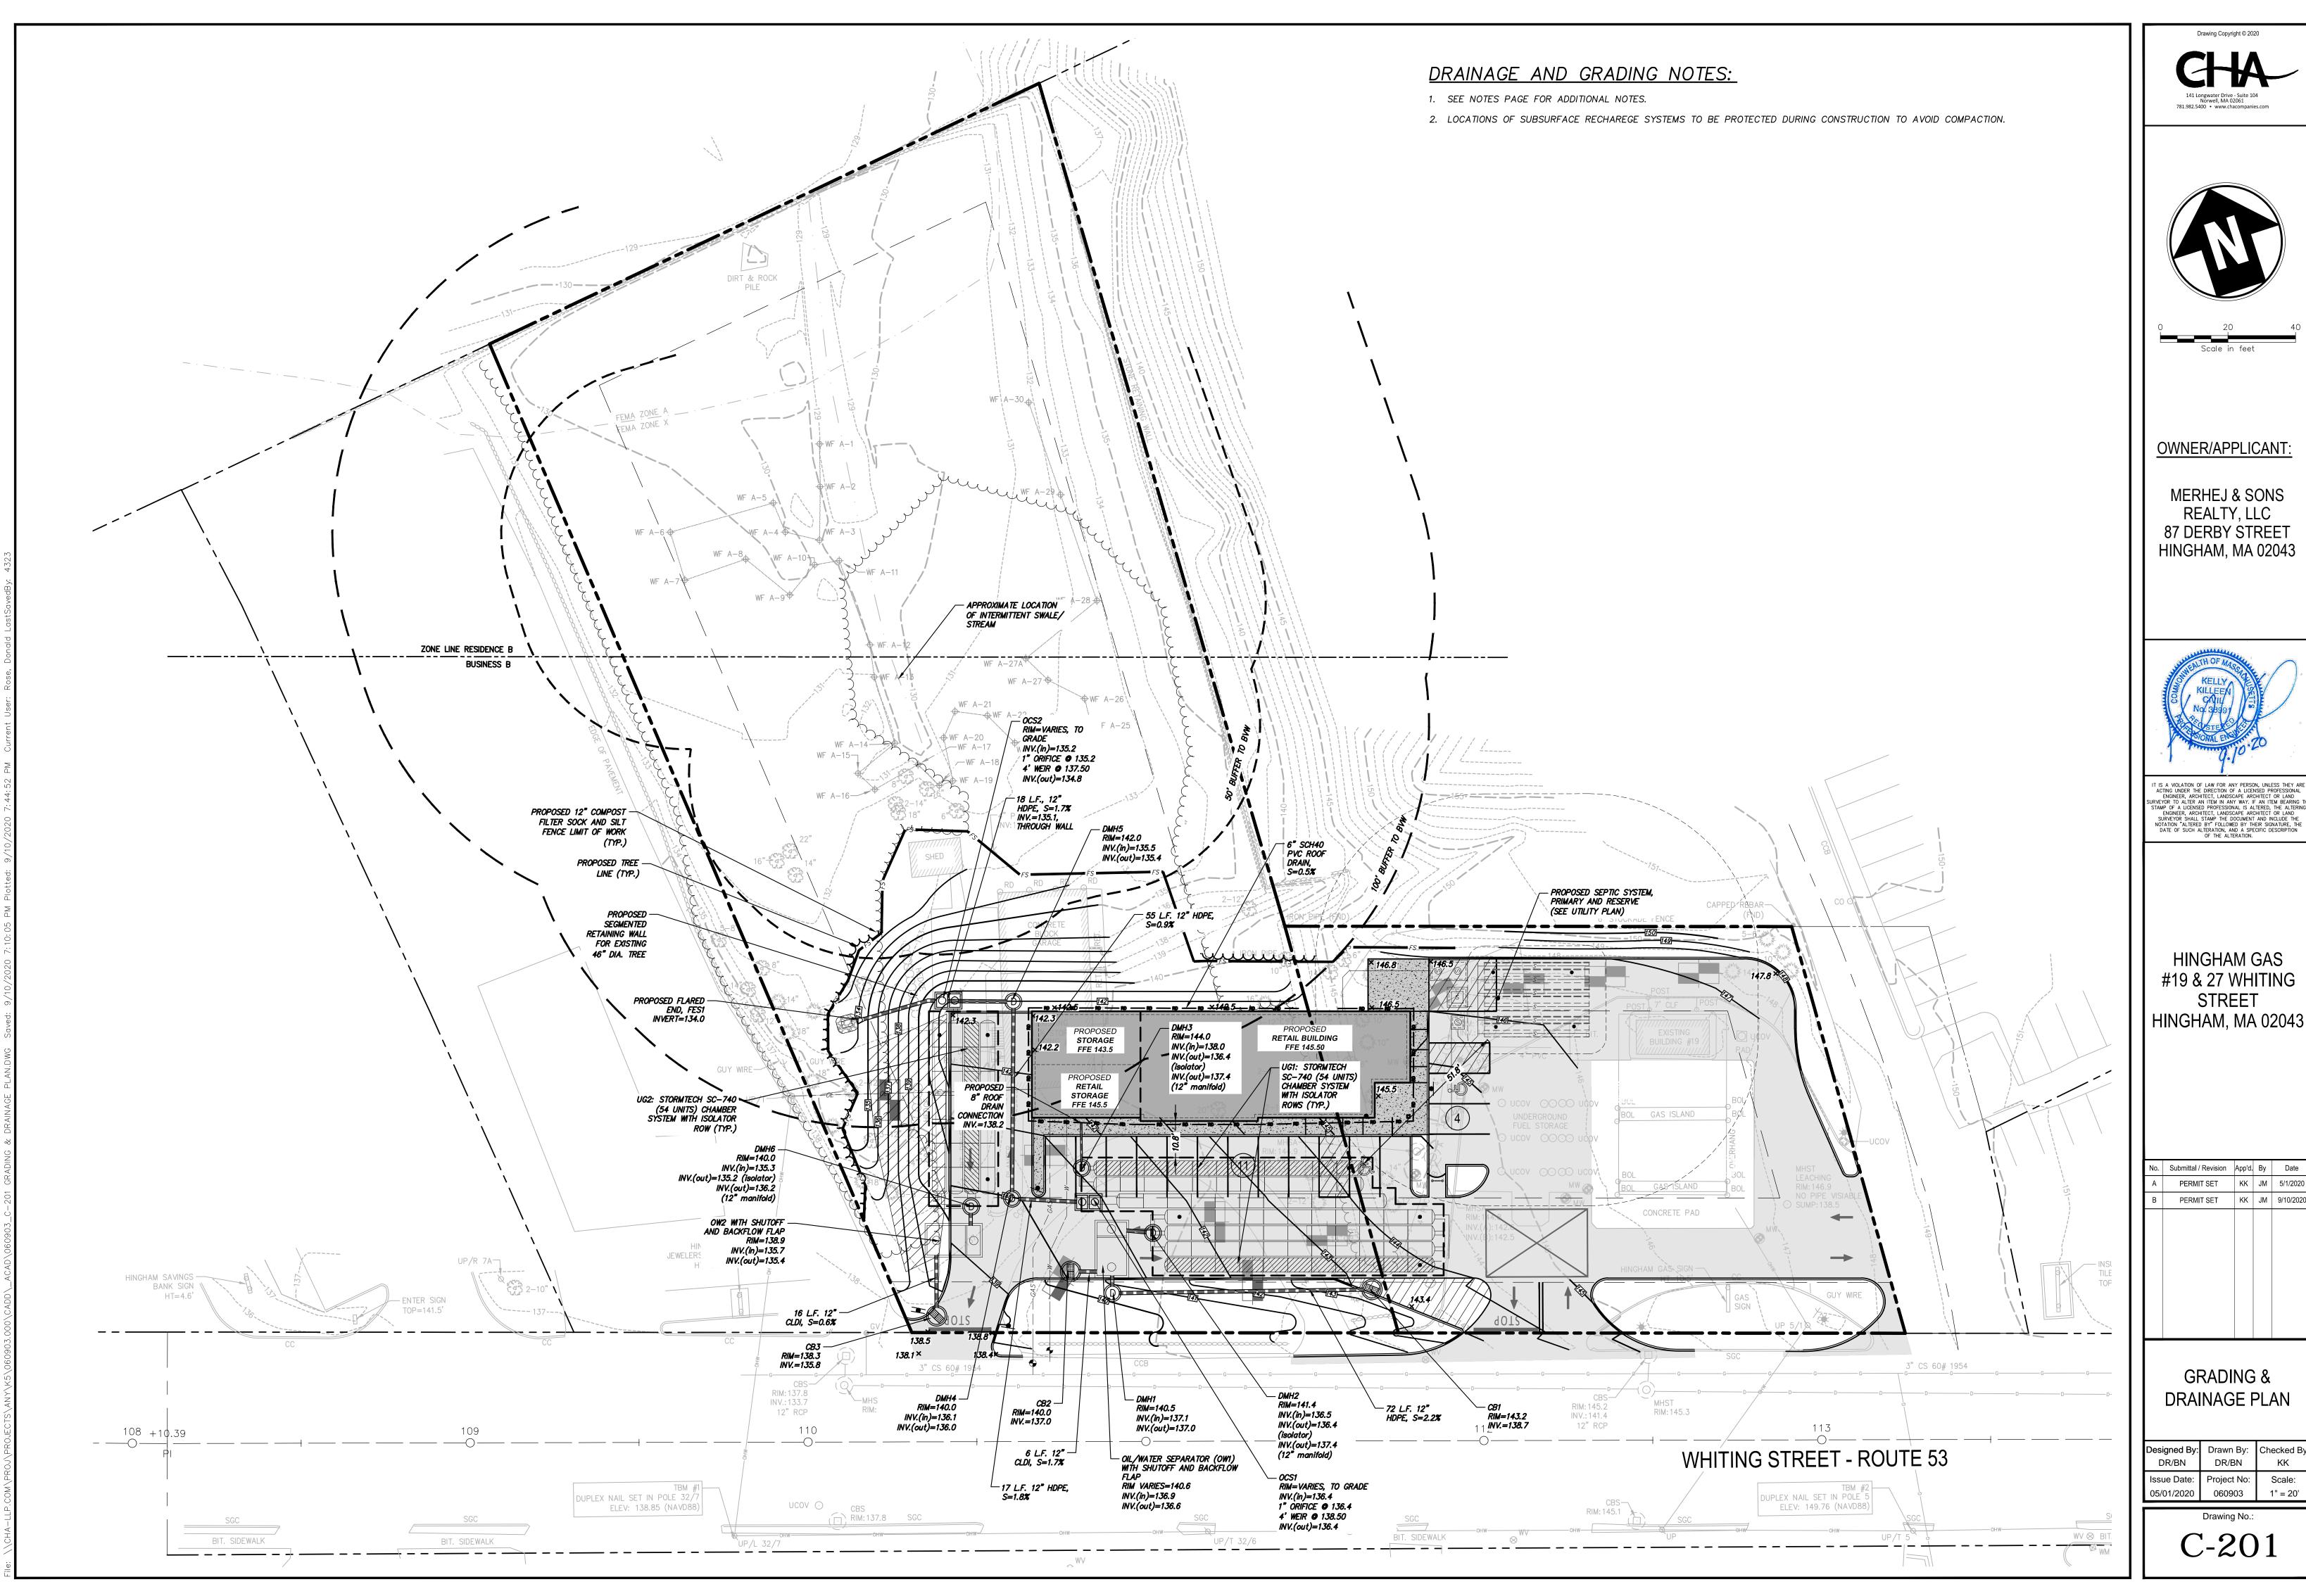

HINGHAM GAS #19 & 27 WHITING

Submittal / Revision	App'd.	Ву	Date	
PERMIT SET	KK	JM	5/1/2020	
PERMIT SET	KK	JM	9/10/2020	
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	Designed By:	Drawn By:	Checked By	
	DR/BN	DR/BN	KK	
	Issue Date:	Project No:	Scale:	
	05/01/2020	060903	1" = 20'	
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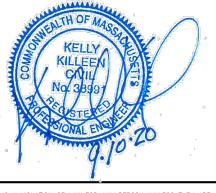




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OWNER/APPLICANT:

MERHEJ & SONS REALTY, LLC 87 DERBY STREET HINGHAM, MA 02043



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OF THE ALTERATION.

HINGHAM GAS #19 & 27 WHITING STREET HINGHAM, MA 02043

Submittal / Revision	App'd.	Ву	Date
PERMIT SET	KK	JM	5/1/2020
PERMIT SET	KK	JM	9/10/2020

UTILITY PLAN

 Designed By:
 Drawn By:
 Checked By

 DR/BN
 DR/BN
 KK

 Issue Date:
 Project No:
 Scale:

 05/01/2020
 060903
 1" = 20'

Drawing No.:

LANDSCAPE NOTES

- 1. THE CONTRACTOR SHALL SUPPLY PLANT MATERIALS IN QUANTITIES SUFFICIENT TO COMPLETE THE WORK SHOWN. ANY DISCREPANCIES BETWEEN QUANTITIES SHOWN ON THE PLANT SCHEDULE AND THOSE REQUIRED BY THE CONTRACT DRAWINGS SHALL NOT ENTITLE THE CONTRACTOR TO ADDITIONAL REMUNERATION.
- 2. THE CONTRACTOR SHALL VERIFY AND VISUALLY INSPECT FINAL SELECTION OF PLANT MATERIALS WITH THE LANDSCAPE ARCHITECT OR OWNER PRIOR TO INSTALLATION.
- 3. ALL PLANTING LOCATIONS SHALL BE STAKED OUT AND APPROVED IN THE FIELD BY THE LANDSCAPE ARCHITECT OR OWNER PRIOR TO INSTALLATION.
- 4. NO PLANT MATERIAL WILL BE ACCEPTED WHICH DISPLAYS MAJOR IRREGULARITIES OR MECHANICAL DAMAGE. THE OWNER RETAINS THE RIGHT TO REJECT ANY PLANT MATERIAL DEEMED UNFIT.
- 5. CONTRACTOR MAY SUBSTITUTE ANY OF THE PLANTINGS LISTED IN THE PLANT SCHEDULE DUE TO AVAILABILITY WITH WRITTEN APPROVAL BY THE LANDSCAPE ARCHITECT OR OWNER PRIOR TO INSTALLATION.
- 6. EXISTING VEGETATION SHALL REMAIN UNDISTURBED IN ALL AREAS WHICH ARE NOT PART OF THE PROPOSED CONTRACT LIMIT LINE.
- 7 GUARANTE
 - A. FOR A PERIOD OF [TWELVE MONTHS] FROM THE DATE THAT THE WORK UNDER THIS CONTRACT IS CERTIFIED AS COMPLETE, THE CONTRACTOR SHALL: 1) GUARANTEE ALL PLANTS AND SEEDED AREAS UNDER THIS CONTRACT; 2) REMOVE AND REPLACE DURING THIS GUARANTEE PERIOD PLANTS WHICH DIE OR ARE IN A BADLY IMPAIRED CONDITION; 3) REPLANT WITH STOCK OF SAME SIZE AND QUALITY AS ORIGINALLY SPECIFIED; 4) GUY AND MAINTAIN AS SPECIFIED HEREIN AT NO ADDITIONAL COST TO THE OWNER.
 - B. REPLACEMENTS MADE WITHIN SIX MONTHS AFTER THE BEGINNING OF THE GUARANTEE PERIOD SHALL NOT EXTEND THE GUARANTEE PERIOD OF THESE PARTICULAR PLANTS. THOSE REPLACEMENTS MADE SIX MONTHS OR MORE AFTER THE BEGINNING OF THE GUARANTEE PERIOD SHALL BE MAINTAINED AND GUARANTEED FOR A PERIOD OF SIX MONTHS FROM THE TIME OF PLACEMENT.
- 8. WATER THOROUGHLY DURING AND IMMEDIATELY AFTER PLANTING.

SEEDING NOTES:

- . WEED SEED CONTENT SHALL NOT EXCEED 0.25%.
- 2. THE SEED MIXTURE SHALL BE DISTRIBUTED BY MEANS OF HYDRO-SEEDING.
- 3. THE FERTILIZER SHALL BE A 5-10-5 COMMERCIAL GRADE FERTILIZER APPLIED AT THE MANUFACTURERS RECOMMENDED APPLICATION RATE.
- 4. SEEDING APPLICATION RATE SHALL BE 4 LBS PER 1,000 SQ. FT.
- 5. WATER THOROUGHLY IMMEDIATELY AFTER SEEDING.
- 6. MAINTAIN AND PROTECT ALL SEEDED AREAS UNTIL A UNIFORM STAND OF GRASS HAS BEEN ESTABLISHED AND ACCEPTED BY THE OWNER'S REPRESENTATIVE.

TOPSOIL NOTES:

- 1. ALL AREAS OF THE SITE WHICH ARE DISTURBED AND NOT PLANTED, MULCHED, PAVED, ETC. SHALL BE TOPSOILED AND SEEDED.
- 2. TOPSOIL TO BE INSTALLED TO A MINIMUM 4" DEPTH IN LAWN AREAS AND 12"IN PLANTING BEDS.
- 3. TOPSOIL SHALL CONSIST OF FERTILE, FRIABLE, NATURAL LOAM FREE OF SUBSOIL, CLAY LUMPS, BRUSH, TWIGS, ENVIRONMENTAL CONTAMINANTS, STONES OR OTHER DELETERIOUS MATERIALS LARGER THAN 1.5" IN GREATEST DIMENSION.
- 4. PROPOSED TOPSOIL SHALL BE TESTED BY AN INDEPENDENT TESTING FACILITY WITH TEST RESULTS SUBMITTED TO THE LANDSCAPE ARCHITECT/ENGINEER FOR APPROVAL. CONTRACTOR SHALL PAY FOR ALL TESTING. ACCEPTANCE OF TOPSOIL SHALL BE BASED UPON TEST RESULTS. ONE TEST SHALL BE PERFORMED PER 100 C.Y. OF TOPSOIL. LABORATORY TESTS SHALL INCLUDE THE FOLLOWING:
 - A. SIEVE PARTICLE SIZE ANALYSIS AND GRADIENT OF MINERAL CONTENT.

SCREEN SIZE	% SOIL RETAINED	% SOIL PASSING
1"	0	100
1/4"	3	97
NO. 100	40-60	40-60


- B. CHEMICAL ANALYSIS OF THE FOLLOWING:
- I. PH (BETWEEN 5.5 AND 7.0)
- II. PERCENT OF ORGANIC CONTENT (NO LESS THAN 6% NOR MORE THAN 20%).
- III. NUTRIENT LEVELS OF PHOSPHORUS, POTASSIUM MAGNESIUM, MANGANESE, IRON, ZINC AND CALCIUM
- IV. SOLUBLE SALT
 V. CATION EXCHANGE CAPACITY (CEC).
- C. NATURAL TOPSOIL MAY BE AMENDED WITH APPROVED MATERIALS, BY APPROVED METHODS, TO MEET THE ABOVE SPECIFICATIONS.

SEED MIX SCHEDULE

PERENNANS).




WETLAND SEED MIX APPLICATION RATE: 25LBS/ACRE | 1750 SQ SPECIES: VIRGINIA WILD RYE (ELYMUS VIRGINICUS), LITTLE BLUESTEM (SCHIZACHYRIUM SCOPARIUM), BIG BLUESTEM (ANDROPOGON GERARDII), RED FESCUE (FESTUCA RUBRA), SWITCH GRASS (PANICUM VIRGATUM), PARTRIDGE PEA (CHAMAECRISTA FASCICULATA), PANICLEDLEAF TICK TREFOIL (DESMODIUM PANICULATUM), INDIAN GRASS (SORGHASTRUM NUTANS), BLUE VERVAIN (VERBENA HASTATA), BUTTERFLY MILKWEED (ASCLEPIAS TUBEROSA), BLACK EYED SUSAN (RUDBECKIA HIRTA), COMMON SNEEZEWEED (HELENIUM AUTUNALE), HEATH ASTER (ASTERPILOSUS/SYMPHYOTRICHUM PILOSUM), EARLY GOLDENROD (SOLIDAGO JUNCEA), UPLAND BENTGRASS (AGROSTIS

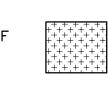

APPLICATION RATE: 23 LBS/ACRE | 1900 SQ FT/LB SPECIES: LITTLE BLUESTEM (SCHIZACHYRIU SCOPARIUM), RED FESCUE (FESTUCA RUBRA), INDIAN GRASS (SORGHASTRUM NUTANS), PARTRIDGE PEA (CHAMAECRISTA FASCICULATA). CANADA WILD RYE (ELYMUS CANADENSIS), VIRGINIA WILD RYE (ELYMUS VIRGINICUS), BLUE VERVAIN (VERBENA HASTATA), BUTTERFLY MILKWEED (ASCLEPIAS TUBEROSA), NARROWLEAFED BLUE EYED GRASS (SISYRINCHIUM ANGUSTIFOLIUM), BLACK EYED SUSAN (RUDBECKIA HIRTA), NEW ENGLAND ASTER (SYMPHYOTRICHUM NOVAE-ANGLIAE), SPIK GAYFEATHER / MARSH BLAZING STAR (LIATRIS SPICATA), STARVED/CALICO ASTE (ASTER LATERIFLORUS/SYMPHYOTRICHUM LATERIFLORUM), EARLY GOLDENROD (SOLIDAGO JUNCEA), HOLLOW-STEM JOE

WILDFLOWER SEED MIX

PYE WEED (EUPATORIUM

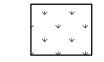

10RF GRASS
60% KENTUCKY BLUEGRASS*
20% CREEPING RED FESCUE
20% PERENNIAL RYEGRASS
*KENTUCKY BLUEGRASS SHALL CONTAIN A
MINIMUM OF TWO VARIETIES.


FISTULOSUM/EUTROCHIUM FISTULOSUM)

4,088 SF

	4,000	SF
UM		
A JS S		
R KED ER		

5 908	CE.

3 C-606

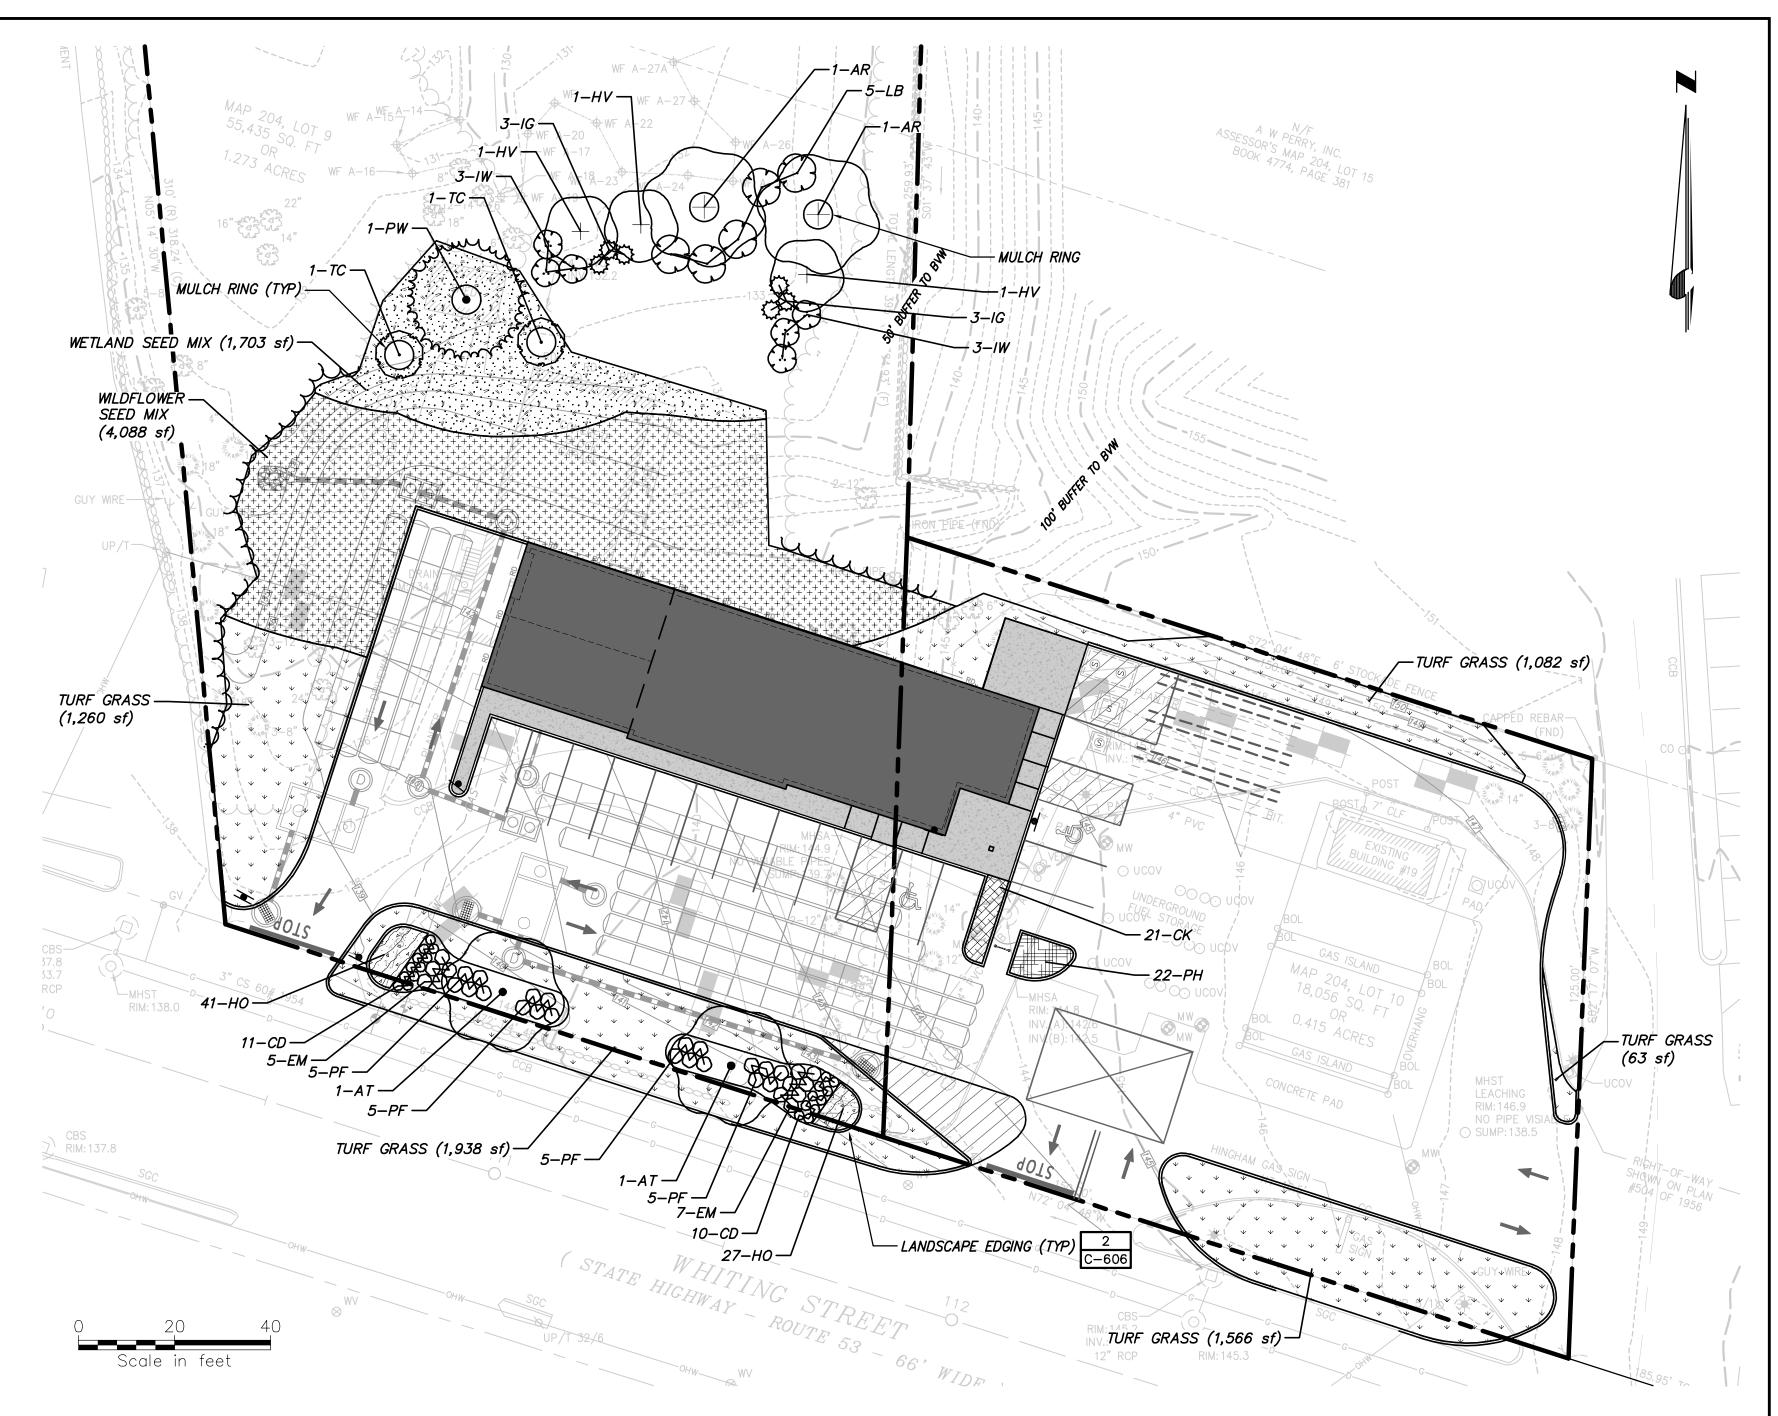

	PLANT	SCHEDULE
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	TREES	QTY	BOTANICAL NAME	COMMON NAME	SIZE	CONTAINER	REMARKS
C-606	AR	2	ACER RUBRUM	RED MAPLE	1.5" CAL.	B&B	REPLACEMENT TREES
	AT	2	ACER RUBRUM 'OCTOBER GLORY'	OCTOBER GLORY RED MAPLE	3" CAL.	B&B	
	PW	1	PINUS ALBA	WHITE PINE	1.5" CAL.	B&B	
	TC	2	TSUGA CANADENSIS	CANADIAN HEMLOCK	8'-10' HT.	B&B	

SHRUBS	QTY	BOTANICAL NAME	COMMON NAME	SIZE	CONTAINER	REMARKS	
CD	21	CARYOPTERIS X CLANDONENSIS 'DARK KNIGHT'	DARK KNIGHT BLUEBEARD	18-24" HT.	CONT.		
EM	12	EUONYMUS FORTUNEI 'MOONSHADOW' TM	MOONSHADOW EUONYMUS	6-12"	1 GAL		
HV	3	HAMAMELIS VIRGINIANA	COMMON WITCH HAZEL	4' HT.	B&B		
IG	6	ILEX GLABRA 'SHAMROCK'	INKBERRY	18-24" HT.	CONT.		
IW	6	ILEX VERTICILLATA	WINTERBERRY	2.5° HT.			
LB	5	LINDERA BENZOIN	SPICEBUSH	2.5° HT.	CONT.		
PF	20	POTENTILLA FRUTICOSA 'PINK BEAUTY'	PINK BEAUTY POTENTILLA	18-24" HT.	CONT.		

	PERENNIALS & GRASSES COD	E QT	TY B	BOTANICAL NAME	COMMON NAME	SIZE	CONTAINER	SPACING	REMARKS
6	СК	21	C	CALAMAGROSTIS X ACUTIFLORA 'KARL FOERSTER'	FEATHER REED GRASS	1' HT.	#1 CONT.	24" o.c.	SPACE 24" O.C
	HO	68	B H	IEMEROCALLIS X 'STELLA DE ORO'	STELLA DE ORO DAYLILY	1' HT.	#1 CONT.	18" o.c.	SPACE 18" O.C
	PH	22	2 P	PENNISETUM ALOPECUROIDES 'HAMELN'	HAMELN FOUNTAIN GRASS	1' HT.	#1 CONT.	24" o.c.	SPACE 24" O.C



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Submittal / Revision	App'd.	Ву	Date
PERMIT SET	NJS	JK	5/1/2020
PERMIT SET	NJS	JK	9/10/2020

LANDSCAPE PLAN

Designed By:	Drawn By:	Checked By:		
JK	JK JK			
Issue Date:	Project No:	Scale:		
05/01/2020	060903	1" = 20'		

Drawing No.:


CONSTRUCTION SPECIFICATIONS:

- 1. STONE SIZE: USE 2" STONE, OR RECLAIMED OR RECYCLED CONCRETE EQUIVALENT.
- 2. LENGTH: RECOMMEND GREATER THAN OR EQUAL TO 50 FEET WHERE SOILS ARE SANDS AND GRAVELS AND 100 FEET IN SILTS AND CLAYS.

SECTION

- 3. THICKNESS: NOT LESS THAN SIX (6) INCHES.
- 4. WIDTH: FIFTEEN (15) FOOT, BUT NOT LESS THAN THE FULL WIDTH AT POINTS WHERE INGRESS OF EGRESS
- 5. FILTER CLOTH: SHALL BE PLACED OVER THE ENTIRE AREA PRIOR TO PLACING OF STONE.
- 6. SURFACE WATER: ALL SURFACE WATER FLOWING OR DIVERTED TOWARD CONSTRUCTION ENTRANCES SHALL BE PIPED ACROSS THE ENTRANCE. IF PIPING IS IMPRACTICAL, A MOUNTABLE BERM SHALL BE INSTALLED.
- 7. MAINTENANCE: THE ENTRANCE SHALL BE MAINTAINED IN A CONDITION WHICH SHALL PREVENT TRACKING OF FLOWING OF SEDIMENT ONTO PUBLIC RIGHTS-OF-WAY. THIS MAY REQUIRE PERIODIC TOP DRESSING WITH ADDITIONAL STONE AS CONDITIONS DEMAND AND REPAIR OR CLEANOUT OF ANY MEASURES USED TO TRAP SEDIMENT. ALL SEDIMENT SPILLED, DROPPED, WASHED OR TRACKED ONTO PUBLIC RIGHTS-OF-WAY MUST BE REMOVED IMMEDIATELY AND ON AN ON GOING BASIS.
- 8. PERIODIC INSPECTION AND NEEDED MAINTENANCE SHALL BE PROVIDED.

STABILIZED CONSTRUCTION ENTRANCE SCALE: NO SCALE

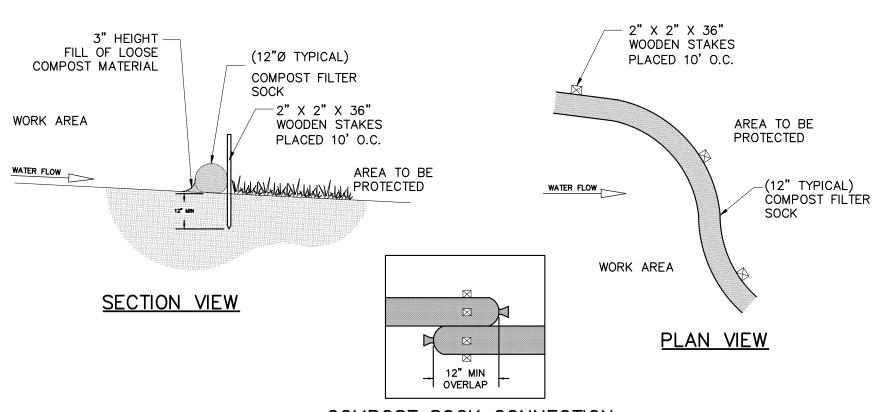

COMPOST SOCK CONNECTION ATTACHMENT DETAIL

1. PREFABRICATED COMPOST SOCK SHALL BE FILTREXX SOXX OR APPROVED EQUAL.

- 2. MATERIAL FOR SOCKS SHALL CONSIST OF SANITIZED MATURE COMPOST, FREE OF VIABLE WEED SEEDS AND FOREIGN DEBRIS SUCH AS GLASS AND PLASTIC. COMPOST SHALL BE IN SHREDDED OR GRANULAR FORM AND FREE FROM HARD LUMPS. IN ADDITION, NO KILN-DRIED WOOD OR CONSTRUCTION DEBRIS SHALL BE ALLOWED. CONTRACTOR SHALL REFER TO MASSDOT SPECIFICATIONS M1.06.0 FOR MATERIAL SPECIFICATIONS.
- 3. SOCK SHALL CONSIST OF JUTE MESH OR OTHER APPROVED BIODEGRADABLE MATERIAL.

PRACTICE: COMPOST FILTER SOCK: A COMPOST FILTER SOCK IS A TYPE OF CONTAINED COMPOST FILTER BERM CONSISTING OF A MESH TUBE FILLED WITH COMPOST MATERIAL THAT IS PLACED PERPENDICULAR TO SHEET FLOW RUNOFF TO RETAIN SEDIMENT FROM DISTURBED AREAS. THE COMPOST FILTER SOCK ACTS AS A FILTER TO RETAIN SEDIMENT AND OTHER POLLUTANTS (E.G., SUSPENDED SOLIDS, NUTRIENTS) WHILE ALLOWING THE WATER TO FLOW THROUGH IT. COMPOST QUALITY MUST MEET AASHTO 2010

INSTALLATIONS REQUIREMENTS:


SPECIFICATIONS.

ONCE THE FILTER SOCK IS FILLED AND PUT IN PLACE, IT SHOULD BE ANCHORED TO THE SLOPE BY STAKES ALONG THE DOWNHILL SIDE OF THE SOCK AT 10' SPACING ON CENTER (O.C.)O THE ENDS OF THE FILTER SOCK SHOULD BE DIRECTED UPSLOPE, TO PREVENT STORMWATER FROM RUNNING AROUND THE END OF THE TUBE.


MAINTENANCE REQUIREMENTS:

SOCK MUST BE INSPECTED FOR SEDIMENT ACCUMULATION. IF THERE IS EXCESSIVE PONDING BEHIND THE FILTER SOCK OR ACCUMULATED SEDIMENT REACHES THE TOP OF THE SOCK, AN ADDITIONAL SOCK SHOULD BE ADDED ON TOP OR INFRONT OF THE EXISTING SOCK IN THESE AREAS. AN ADEQUATE RESERVE OF SOCKS MUST BE KEPT ON SITE AT ALL TIMES FOR EMERGENCY AND/OR ROUTINE REPLACEMENT. SOCKS SHALL BE REMOVED ONLY AFTER EXPOSED SOILS IN THE CONTRIBUTING DRAINAGE AREA ACHIEVE FINAL STABILIZATION. SEDIMENT ACCUMULATION MUST BE REMOVED ONCE IT HAS REACHED 1/2 OF THE EXPOSED HEIGHT OF THE SOCK.

12-INCH COMPOST FILTER SOCK SCALE: NO SCALE

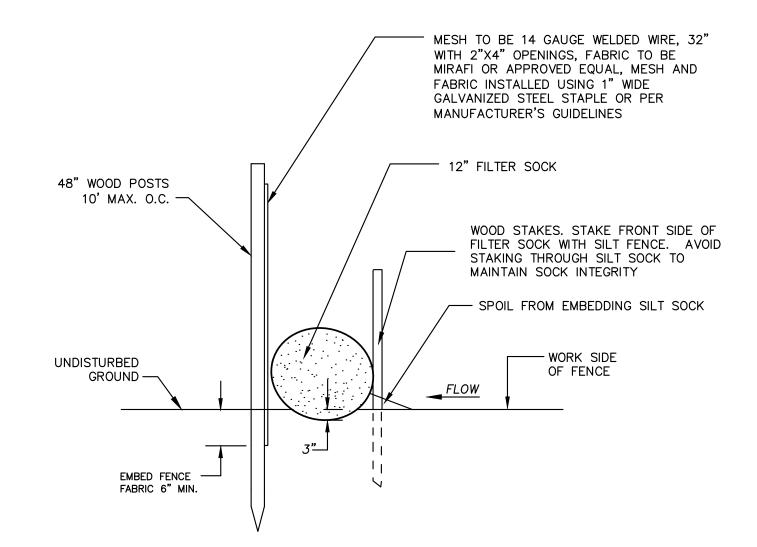


12" FILTER SOCK WITH WIRE BACKED SILT FENCE

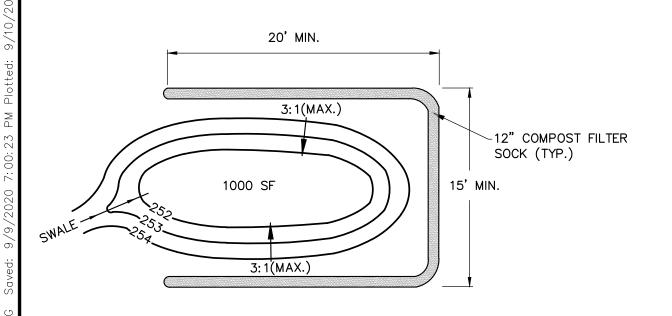

1. SEDIMENT BASINS AND TRAPS SHALL BE SIZED IN ACCORDANCE WITH EPA NPDES GUIDELINES.

- 2. SEDIMENT TRAPS ARE UTILIZED FOR DRAINAGE AREAS SMALLER THAN 5 ACRES. THE SEDIMENT TRAP SHOULD HAVE A MINIMUM VOLUME BASED ON 1/2 INCH OF STORAGE FOR EACH ACRE OF DRAINAGE AREA. THIS VOLUME EQUATES TO 1800 CUBIC FEET OF STORAGE OR 67 CUBIC YARDS FOR EACH ACRE OF DRAINAGE AREA.
- 3. SEDIMENT BASIN ARE UTILIZED FOR DRAINAGE AREAS FROM 5 TO 100 ACRES. THE TEMPORARY SEDIMENT BASIN SHOULD HAVE A MINIMUM VOLUME OF 3,600 CUBIC FEET FOR EACH ACRE OF DRAINAGE AREA.
- 4. LOCATION DICTATED BY SEQUENCE OF CONSTRUCTION. CONTRACTOR TO PROVIDE WHERE NECESSARY TO FILTER RUNOFF FROM CONSTRUCTION AREAS PRIOR TO DISCHARGE.
- 5. SEDIMENT BASIN TO HAVE 12" VERTICAL PERFORATED PIPE WRAPPED WITH FILTER FABRIC AND SCREEN ON TOP FOR OVERFLOW.


TEMPORARY SEDIMENT BASIN SCALE: NO SCALE

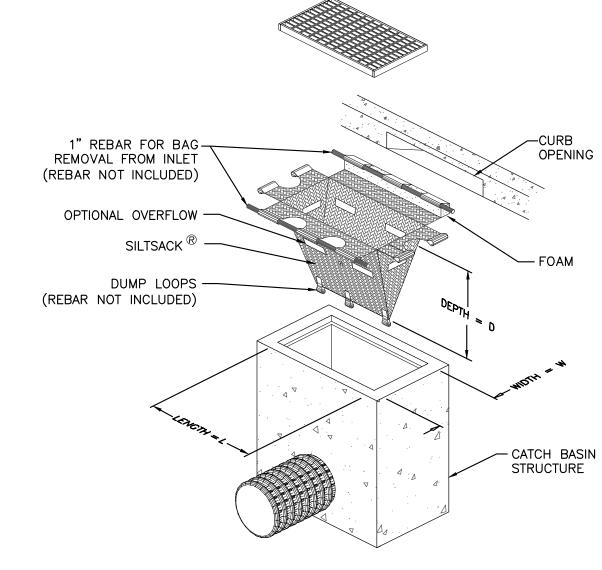

ISOMETRIC VIEW


- 1. REMOVE ACCUMULATED SEDIMENT WHEN CAPACITY IS REDUCED BY HALF OR PER MANUFACTURER'S RECOMMENDATIONS.
- 2. CATCH BASIN INSERT TO BE SILTSACK $^{\circledR}$ BY ACF ENVIRONMENTAL, PHONE: 1-800-448-3636, acfenvironmental.com OR EQUIVALENT.
- 3. INSTALL ON ALL EXISTING CATCH BASINS WITHIN SNOW BIRD AVENUE AND ADJACENT CATCH BASINS ON INTERSECTION ROADS IF ROADWAY DRAINAGE CAN REACH THOSE.

FILTER SACK CATCH BASIN INSERT DETAIL

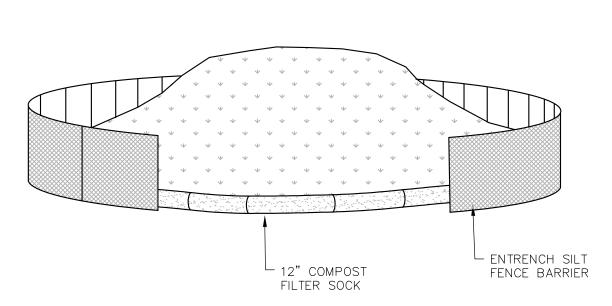

INSTALLATION NOTES:

- 1. AREA CHOSEN FOR STOCKPILING OPERATIONS SHALL BE DRY AND STABLE.
- 2. MAXIMUM SLOPE OF STOCKPILE SHALL BE 2:1.
- 3. UPON COMPLETION OF STOCKPILING, EACH PILE SHALL BE SURROUNDED WITH COMOST FILTER SOCK, THEN STABILIZED WITH VEGETATION, OR
- 4. SEE SPECIFICATIONS FOR INSTALLATION OF COMPOST FILTER SOCKS.

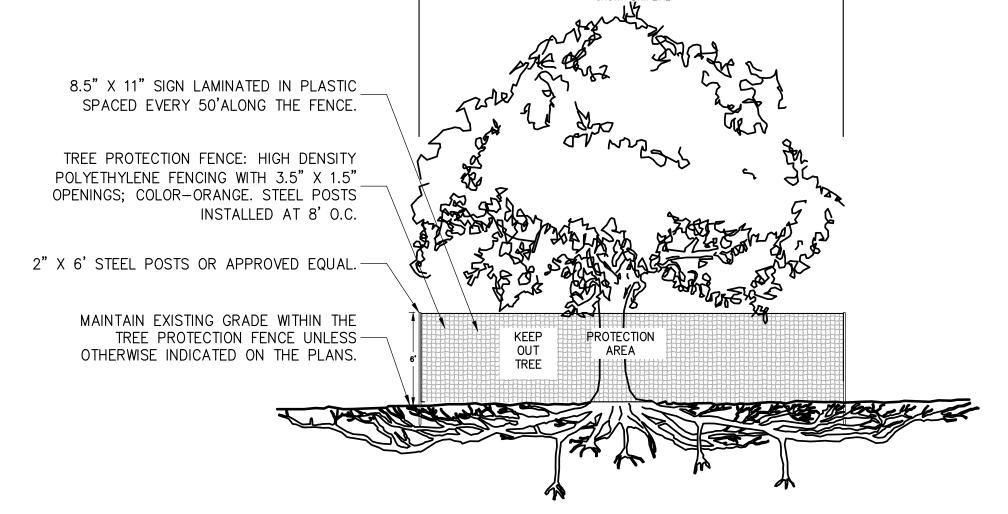

- 1. CONTRACTOR TO MAINTAIN INTEGRITY OF CONSTRUCTION FENCE FOR
- DURATION OF PROJECT. NO PRUNING SHALL BE PERFORMED EXCEPT BY APPROVED ARBORIST.
- NO EQUIPMENT SHALL OPERATE INSIDE THE PROTECTIVE FENCING INCLUDING DURING FENCE INSTALLATION AND REMOVAL
- 4. SEE SITE PREPARATION PLAN FOR ANY MODIFICATIONS WITH THE TREE


PROTECTION AREA.

TREE PROTECTION

OWNER/APPLICANT:

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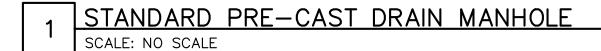
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0.	Submittal / Revision	App'd.	Ву	Date
4	PERMIT SET	KK	JM	5/1/2020
3	PERMIT SET	KK	JM	9/10/202

SITE DETAILS

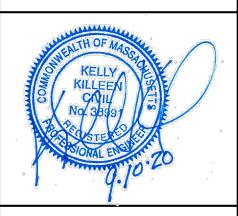Designed By: DR/BN	Drawn By: DR/BN	Checked By: KK
Issue Date:	Project No:	Scale:
05/01/2020	060903	

- 1. STANDARD PRECAST DRAIN MANHOLE BY SCITUATE PRECAST OR APPROVED EQUAL. CONTRACTOR TO SUBMIT SHOP DRAWINGS FOR APPROVAL PRIOR TO CONSTRUCTION.
- 2. CONTRACTOR SHALL PROVIDE SIGNED & SEALED BUOYANCY CALCULATIONS FOR ALL PRECAST STRUCTURES WITH SHOP DRAWINGS SUBMITTED TO CHA. CALCULATIONS SHALL ASSUME THE HIGHER OF FEMA FLOODPLAIN ELEVATION OR SEASONAL HIGH GROUNDWATER ELEVATION FOR GROUNDWATER DEPTH AT EACH STRUCTURE WITH A 1.15 FACTOR OF SAFETY APPLIED TO THE UPLIFT.




INDICATED IN THE CALCULATION, HOWEVER FOR


PLANS FOR LOCATION AND INVERT INFORMATION.

PLUNGE POOL/ENERGY DISSIPATER

CONSTRUCTIBILITY PURPOSES WE HAVE PROVIDED A LARGER


RIP-RAP APRON SIZE. REFER TO GRADING & DRAINAGE

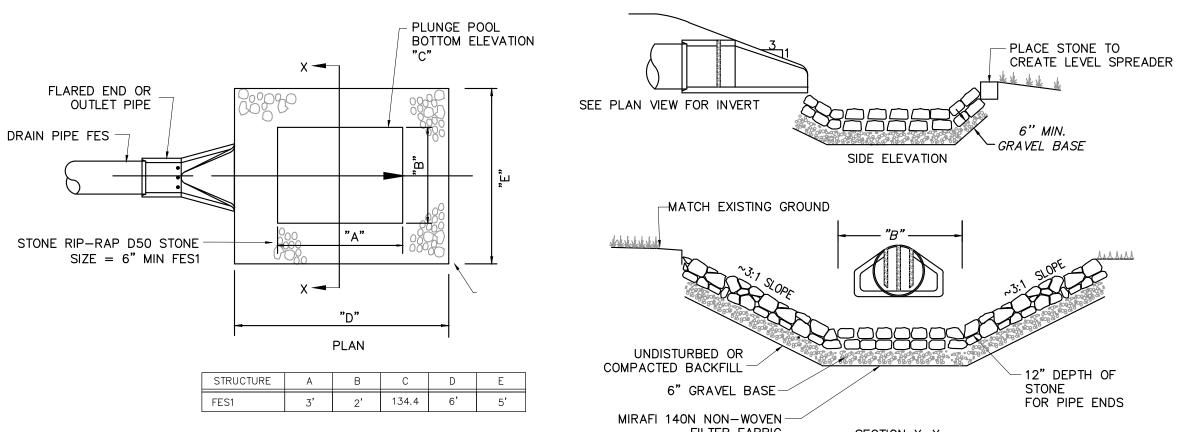

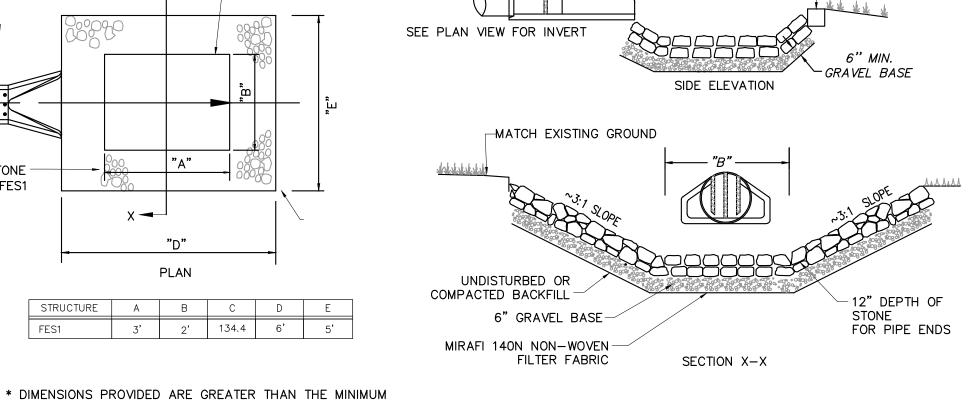


- 1. STANDARD PRECAST DRAIN MANHOLE BY SCITUATE PRECAST OR APPROVED EQUAL. CONTRACTOR TO SUBMIT SHOP DRAWINGS FOR APPROVAL PRIOR TO CONSTRUCTION.
- 2. CONTRACTOR SHALL PROVIDE SIGNED & SEALED BUOYANCY CALCULATIONS FOR ALL PRECAST STRUCTURES WITH SHOP DRAWINGS SUBMITTED TO CHA. CALCULATIONS SHALL ASSUME THE HIGHER OF FEMA FLOODPLAIN ELEVATION OR SEASONAL HIGH GROUNDWATER ELEVATION FOR GROUNDWATER DEPTH AT EACH STRUCTURE WITH A 1.15 FACTOR OF SAFETY APPLIED TO THE UPLIFT.


6,000 GALLON OIL/WATER SEPARATOR

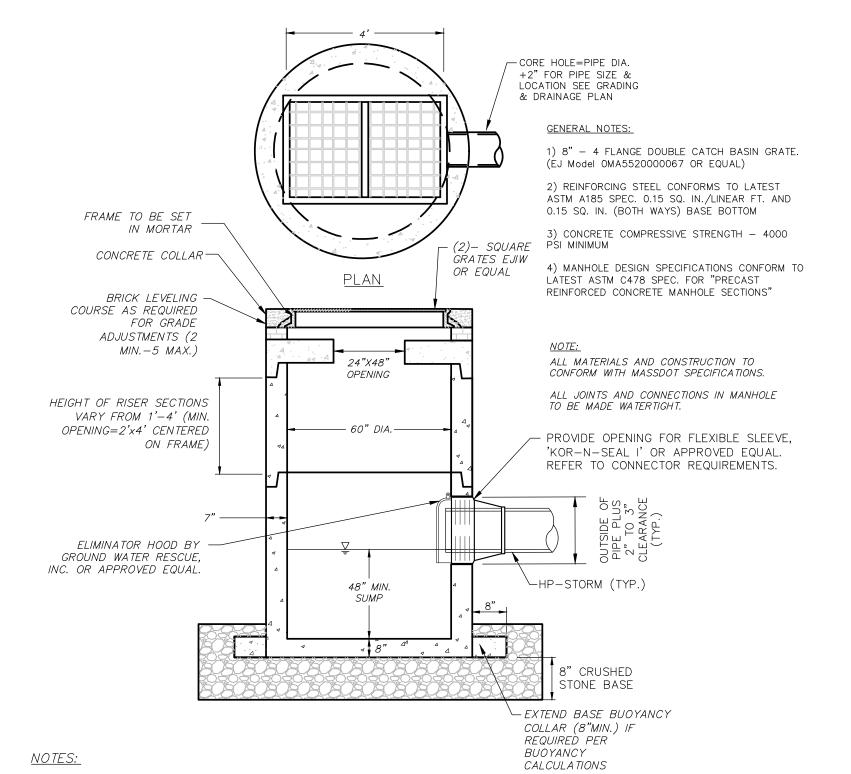


- 1. STANDARD PRECAST DRAIN MANHOLE BY SCITUATE PRECAST OR APPROVED EQUAL. CONTRACTOR TO SUBMIT SHOP DRAWINGS FOR APPROVAL PRIOR TO CONSTRUCTION.
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TOP VIE	_VV						
	PIPE DIAMETER, (inches)						
DIAMETER	12	15	18	24	30	36	
Α	6.5	6.5	7.5	7.5	7.5	7.5	
B (max)	10.0	10.0	15.0	18.0	22.0	25.0	
н	6.5	6.5	6.5	6.5	8.6	8.6	
L	25.0	25.0	32.0	36.0	58.0	58.0	
w	29.0	29.0	35.0	45.0	63.0	63.0	


ADS FLARED END SECTION SPECIFICATION:

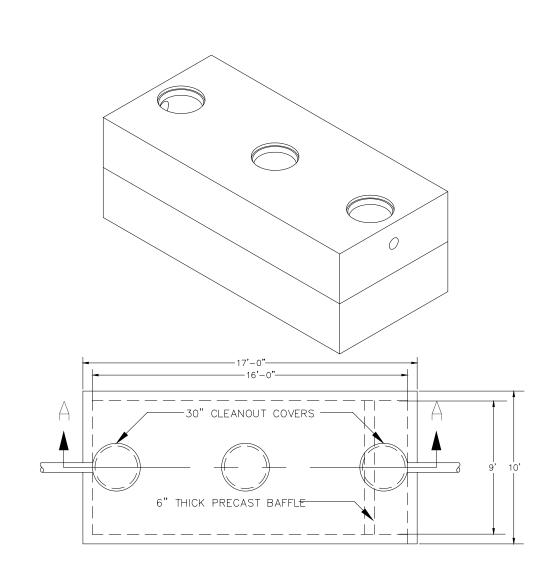
THIS SPECIFICATION DESCRIBES 12- THROUGH 36-INCH (300 TO 900MM) ADS FLARED END SECTIONS FOR USE IN CULVERT AND DRAINAGE OUTLET APPLICATIONS.

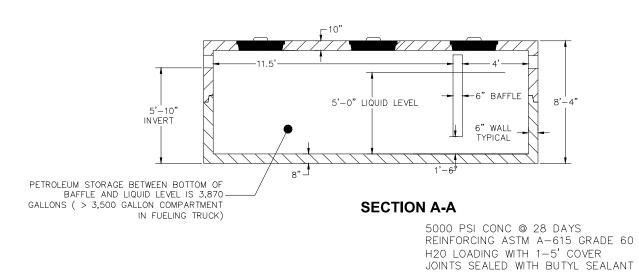REQUIREMENTS
THE INVERT OF THE PIPE AND THE END SECTION SHALL BE AT THE SAME ELEVATION. THE ADS FLARED END SECTION SHALL BE HIGH DENSITY POLYETHYLENE MEETING ASTM D3350 MINIMUM CELL CLASSIFICATION 213320C; CONTACT MANUFACTURER FOR ADDITIONAL CELL CLASSIFICATION INFORMATION. WHEN PROVIDED, THE METAL THREADED FASTENING ROD SHALL BE STAINLESS STEEL.

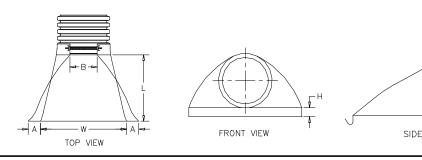INSTALLATION SHALL BE IN ACCORDANCE WITH ADS INSTALLATION INSTRUCTIONS AND WITH THOSE ISSUED BY STATE OR LOCAL AUTHORITIES.



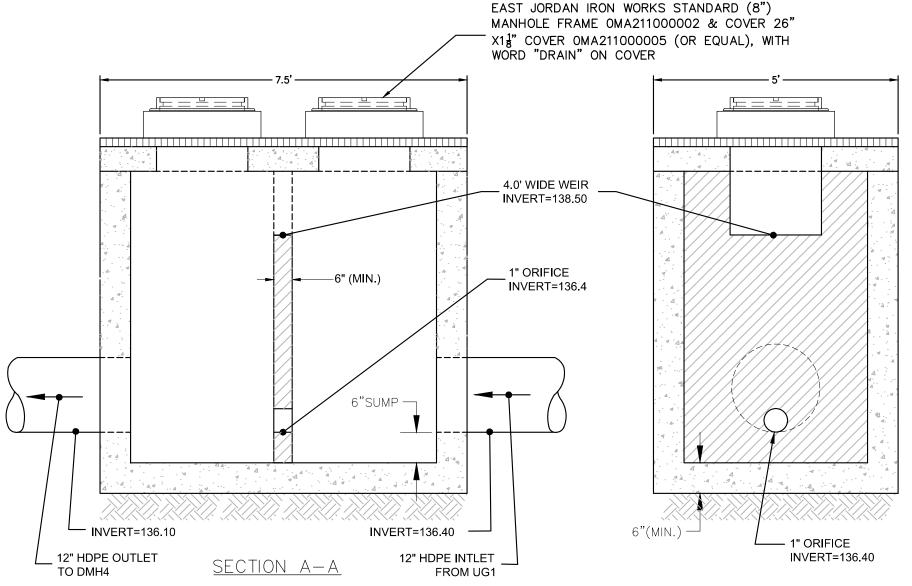

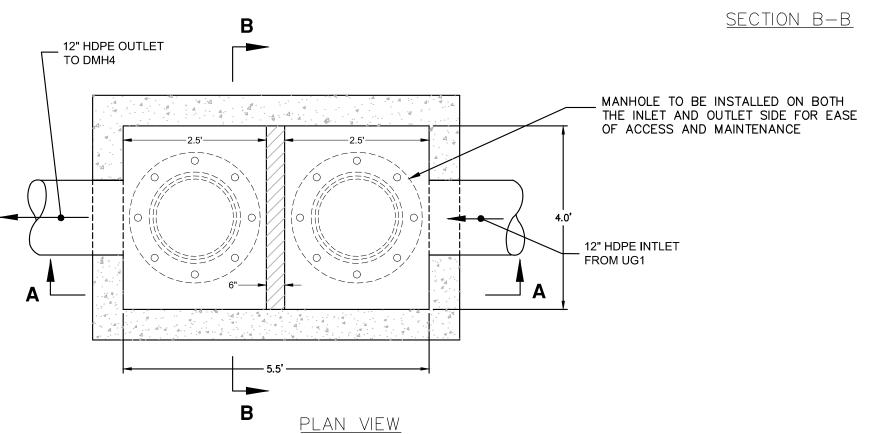

OUTLET CONTROL STRUCTURE (OCS-1) SCALE: NO SCALE



OWNER/APPLICANT:

MERHEJ & SONS REALTY, LLC 87 DERBY STREET HINGHAM, MA 02043



HINGHAM GAS #19 & 27 WHITING STREET HINGHAM, MA 02043

١.	Submittal / Revision	App'd.	Ву	Date
	PERMIT SET	KK	JM	5/1/2020
	PERMIT SET	KK	JM	9/10/2020

SITE DETAILS

Designed By:	Drawn By:	Checked By:
DR/BN	DR/BN	KK
Issue Date:	Project No:	Scale:
05/01/2020	060903	

ACCEPTABLE FILL MATERIALS: STORMTECH SC-740 CHAMBER SYSTEMS

	MATERIAL LOCATION	DESCRIPTION	AASHTO MATERIAL CLASSIFICATIONS	COMPACTION / DENSITY REQUIREMENT
D	FINAL FILL: FILL MATERIAL FOR LAYER 'D' STARTS FROM THE TOP OF THE 'C' LAYER TO THE BOTTOM OF FLEXIBLE PAVEMENT OR UNPAVED FINISHED GRADE ABOVE. NOTE THAT PAVEMENT SUBBASE MAY BE PART OF THE 'D' LAYER	ANY SOIL/ROCK MATERIALS, NATIVE SOILS, OR PER ENGINEER'S PLANS. CHECK PLANS FOR PAVEMENT SUBGRADE REQUIREMENTS.	N/A	PREPARE PER SITE DESIGN ENGINEER'S PLANS. PAVED INSTALLATIONS MAY HAVE STRINGENT MATERIAL AND PREPARATION REQUIREMENTS.
С	INITIAL FILL: FILL MATERIAL FOR LAYER 'C' STARTS FROM THE TOP OF THE EMBEDMENT STONE ('B' LAYER) TO 18" (450 mm) ABOVE THE TOP OF THE CHAMBER. NOTE THAT PAVEMENT SUBBASE MAY BE A PART OF THE 'C' LAYER.	GRANULAR WELL-GRADED SOIL/AGGREGATE MIXTURES, <35% FINES OR PROCESSED AGGREGATE. MOST PAVEMENT SUBBASE MATERIALS CAN BE USED IN LIEU OF THIS LAYER.	AASHTO M145 ¹ A-1, A-2-4, A-3 OR AASHTO M43 ¹ 3, 357, 4, 467, 5, 56, 57, 6, 67, 68, 7, 78, 8, 89, 9, 10	BEGIN COMPACTIONS AFTER 12" (300 mm) OF MATERIAL OVER THE CHAMBERS IS REACHED. COMPACT ADDITIONAL LAYERS IN 6" (150 mm) MAX LIFTS TO A MIN. 95% PROCTOR DENSITY FOR WELL GRADED MATERIAL AND 95% RELATIVE DENSITY FOR PROCESSED AGGREGATE MATERIALS. ROLLER GROSS VEHICLE WEIGHT NOT TO EXCEED 12,000 lbs (53 kN). DYNAMIC FORCE NOT TO EXCEED 20,000 lbs (89 kN).
В	EMBEDMENT STONE: FILL SURROUNDING THE CHAMBERS FROM THE FOUNDATION STONE ('A' LAYER) TO THE 'C' LAYER ABOVE.	CLEAN, CRUSHED, ANGULAR STONE, NOMINAL SIZE DISTRIBUTION BETWEEN 3/4-2 INCH (20-50 mm)	AASHTO M43 ¹ 3, 357, 4, 467, 5, 56, 57	NO COMPACTION REQUIRED.
А	FOUNDATION STONE: FILL BELOW CHAMBERS FROM THE SUBGRADE UP TO THE FOOT (BOTTOM) OF THE CHAMBER.	CLEAN, CRUSHED, ANGULAR STONE, NOMINAL SIZE DISTRIBUTION BETWEEN 3/4-2 INCH (20-50 mm)	AASHTO M43 ¹ 3, 357, 4, 467, 5, 56, 57	PLATE COMPACT OR ROLL TO ACHIEVE A FLAT SURFACE. 2 3


PLEASE NOTE: 1. THE LISTED AASHTO DESIGNATIONS ARE FOR GRADATIONS ONLY. THE STONE MUST ALSO BE CLEAN, CRUSHED, ANGULAR. FOR EXAMPLE, A SPECIFICATION FOR #4 STONE WOULD STATE: "CLEAN,

- CRUSHED, ANGULAR NO. 4 (AASHTO M43) STONE". 2. STORMTECH COMPACTION REQUIREMENTS ARE MET FOR 'A' LOCATION MATERIALS WHEN PLACED AND COMPACTED IN 6" (150 mm) (MAX) LIFTS USING TWO FULL COVERAGES WITH A VIBRATORY
- 3. WHERE INFILTRATION SURFACES MAY BE COMPROMISED BY COMPACTION, FOR STANDARD DESIGN LOAD CONDITIONS, A FLAT SURFACE MAY BE ACHIEVED BY RAKING OR DRAGGING WITHOUT COMPACTION EQUIPMENT. FOR SPECIAL LOAD DESIGNS, CONTACT STORMTECH FOR COMPACTION REQUIREMENTS.

ADS GEOSYNTHETICS 601T NC AROUND CLEAN, CRUSHED, A		PAVEMENT LAYER (DESIGNED BY SITE ENGINEER)	DESIGN
PERIMETER STONE (SEE NOTE 6)		*TO BOTTOM OF FLEXIBLE PAVEMENT. FOR UNPAVED INSTALLATIONS WHERE RUTTING FROM VEHICLES MAY OCCUR, INCREASE COVER TO 24" (600 mm).	8' 18" (2.4 m) (450 mm) MIN* MAX
EXCAVATION WALL (CAN BE SLOPED OR VERTICAL)	B		6" (150 mm) MIN 30" (760 mm)
12" (300 mm) MIN	SC-740 ND CAP SUBGRADE SOILS (150 (SEE NOTE 5)	6" mm) MIN 51" (1295 mm)	DEPTH OF STONE TO BE DETERMINED BY DESIGN ENGINEER 6" (150 mm) MI 12" (300 mm) TYP

NOTES:

- 1. SC-740 CHAMBERS SHALL CONFORM TO THE REQUIREMENTS OF ASTM F2418 "STANDARD SPECIFICATION FOR POLYPROPYLENE (PP) CORRUGATED WALL STORMWATER COLLECTION CHAMBERS", OR ASTM F2922 "STANDARD SPECIFICATION FOR POLYETHYLENE (PE) CORRUGATED WALL STORMWATER COLLECTION CHAMBERS".
- 2. SC-740 CHAMBERS SHALL BE DESIGNED IN ACCORDANCE WITH ASTM F2787 "STANDARD PRACTICE FOR STRUCTURAL DESIGN OF THERMOPLASTIC CORRUGATED WALL STORMWATER COLLECTION CHAMBERS".
- 3. "ACCEPTABLE FILL MATERIALS" TABLE ABOVE PROVIDES MATERIAL LOCATIONS, DESCRIPTIONS, GRADATIONS, AND COMPACTION REQUIREMENTS FOR FOUNDATION, EMBEDMENT, AND FILL MATERIALS.
- 4. THE "SITE DESIGN ENGINEER" REFERS TO THE ENGINEER RESPONSIBLE FOR THE DESIGN AND LAYOUT OF THE STORMTECH CHAMBERS FOR THIS PROJECT.
- 5. THE SITE DESIGN ENGINEER IS RESPONSIBLE FOR ASSESSING THE BEARING RESISTANCE (ALLOWABLE BEARING CAPACITY) OF THE SUBGRADE SOILS AND THE DEPTH OF FOUNDATION STONE WITH CONSIDERATION FOR THE RANGE OF EXPECTED SOIL MOISTURE CONDITIONS.
- 6. PERIMETER STONE MUST BE EXTENDED HORIZONTALLY TO THE EXCAVATION WALL FOR BOTH VERTICAL AND SLOPED EXCAVATION WALLS.
- 7. ONCE LAYER 'C' IS PLACED, ANY SOIL/MATERIAL CAN BE PLACED IN LAYER 'D' UP TO THE FINISHED GRADE. MOST PAVEMENT SUBBASE SOILS CAN BE USED TO REPLACE THE MATERIAL REQUIREMENTS OF LAYER 'C' OR 'D' AT THE SITE DESIGN ENGINEER'S DISCRETION.
- 8. STORMTECH SC-740 UNITS TO BE H20 RATED FOR VEHICLE LOADS.

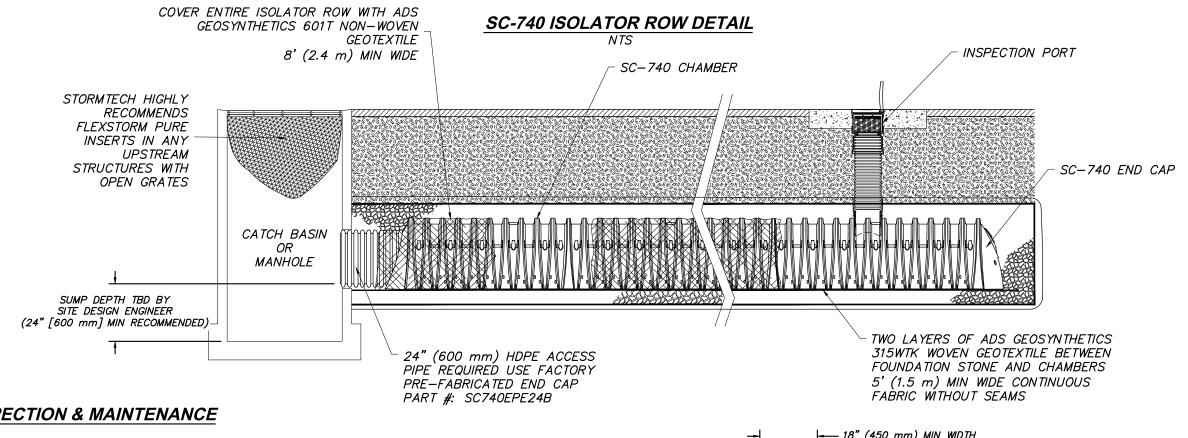


INSPECTION & MAINTENANCE

STEP 1) INSPECT ISOLATOR ROW FOR SEDIMENT

- A. INSPECTION PORTS (IF PRESENT) REMOVE/OPEN LID ON NYLOPLAST INLINE DRAIN
- REMOVE AND CLEAN FLEXSTORM FILTER IF INSTALLED 3. USING A FLASHLIGHT AND STADIA ROD, MEASURE DEPTH OF SEDIMENT AND RECORD ON MAINTENANCE LOG
- 4. LOWER A CAMERA INTO ISOLATOR ROW FOR VISUAL INSPECTION OF SEDIMENT LEVELS (OPTIONAL)
- 5. IF SEDIMENT IS AT, OR ABOVE, 3" (80 mm) PROCEED TO STEP 2. IF NOT, PROCEED TO STEP 3.
- B. ALL ISOLATOR ROWS 1. REMOVE COVER FROM STRUCTURE AT UPSTREAM END OF ISOLATOR
- 2. USING A FLASHLIGHT, INSPECT DOWN THE ISOLATOR ROW THROUGH OUTLET PIPE 2.1. MIRRORS ON POLES OR CAMERAS MAY BE USED TO AVOID A
- CONFINED SPACE ENTRY 2.2. FOLLOW OSHA REGULATIONS FOR CONFINED SPACE ENTRY IF ENTERING MANHOLE 3. IF SEDIMENT IS AT, OR ABOVE, 3" (80 mm) PROCEED TO STEP 2. IF
- STEP 2) CLEAN OUT ISOLATOR ROW USING THE JETVAC PROCESS 1. A FIXED CULVERT CLEANING NOZZLE WITH REAR FACING SPREAD OF


NOT, PROCEED TO STEP 3.

- 45" (1.1 m) OR MORE IS PREFERRED 2. APPLY MULTIPLE PASSES OF JETVAC UNTIL BACKFLUSH WATER IS
- 3. VACUUM STRUCTURE SUMP AS REQUIRED
- STEP 3) REPLACE ALL COVERS, GRATES, FILTERS, AND LIDS; RECORD OBSERVATIONS
- STEP 4) INSPECT AND CLEAN BASINS AND MANHOLES UPSTREAM OF THE STORMTECH
 - STORMTECH SC-740 CHAMBER UNIT SYSTEM

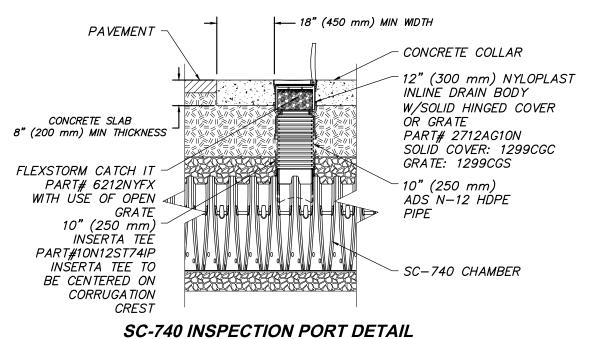

- 1. INSPECT EVERY 6 MONTHS DURING THE FIRST YEAR OF OPERATION. ADJUST THE INSPECTION INTERVAL BASED ON PREVIOUS OBSERVATIONS OF SEDIMENT ACCUMULATION AND HIGH WATER ELEVATIONS.
- 2. CONDUCT JETTING AND VACTORING ANNUALLY OR WHEN INSPECTION SHOWS THAT MAINTENANCE IS NECESSARY.


SC-740 TECHNICAL SPECIFICATION

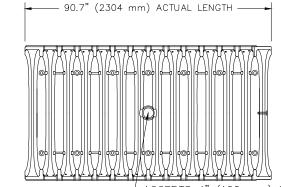



85.4" (2169 mm) INSTALLED LENGTH -> BUILD ROW IN THIS DIRECTION - START END OVERLAP NEXT CHAMBER HERE


└ (OVER SMALL CORRUGATION)

ACCEPTS 4" (100 mm) SCH 40 PVC PIPE FOR INSPECTION PORT. FOR PIPE SIZES LARGER THAN ⁻ 4" (100 mm) UP TO 10" (250 mm) USE INSERTA TEE CONNECTION CENTERED ON A CHAMBER

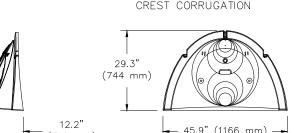

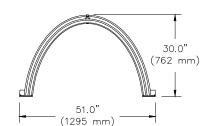

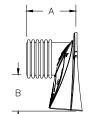

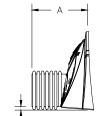

NOMINAL CHAMBER SPECIFICATIONS

WFIGHT

51.0" X 30.0" X 85.4" (1295 mm X 762 mm X 2169 mm) SIZE (W X H X INSTALLED LENGTH) 45.9 CUBIC FEET (1.30 m³) CHAMBER STORAGE MINIMUM INSTALLED STORAGE* 74.9 CUBIC FEET (2.12 m³) (33.6 kg)

*ASSUMES 6" (152 mm) STONE ABOVE, BELOW, AND BETWEEN CHAMBERS

75.0 lbs.

STUBS AT BOTTOM OF END CAP FOR PART NUMBERS ENDING WITH "B" STUBS AT TOP OF END CAP FOR PART NUMBERS ENDING WITH "T"


PART#	STUB	Α	В	С
SC740EPE06T / SC740EPE06TPC	6" (150 mm)	10.9" (277 mm)	18.5" (470 mm)	
SC740EPE06B / SC740EPE06BPC	0 (130 11111)	10.9 (277 11111)		0.5" (13 mm)
SC740EPE08T /SC740EPE08TPC			16.5" (419 mm)	
SC740EPE08B / SC740EPE08BPC	8" (200 mm)	12.2" (310 mm)		0.6" (15 mm)
SC740EPE10T / SC740EPE10TPC			14.5" (368 mm)	
SC740EPE10B / SC740EPE10BPC	10" (250 mm)	13.4" (340 mm)		0.7" (18 mm)
SC740EPE12T / SC740EPE12TPC			12.5" (318 mm)	
SC740EPE12B / SC740EPE12BPC	12" (300 mm)	14.7" (373 mm)		1.2" (30 mm)
SC740EPE15T / SC740EPE15TPC			9.0" (229 mm)	
SC740EPE15B / SC740EPE15BPC] 15" (375 mm)	18.4" (467 mm)		1.3" (33 mm)
SC740EPE18T / SC740EPE18TPC			5.0" (127 mm)	
SC740EPE18B / SC740EPE18BPC] 18" (450 mm)	19.7" (500 mm)		1.6" (41 mm)
SC740EPE24B*	24" (600 mm)	18.5" (470 mm)		0.1" (3 mm)


ALL STUBS, EXCEPT FOR THE SC740EPE24B ARE PLACED AT BOTTOM OF END CAP SUCH THAT THE OUTSIDE DIAMETER OF THE STUB IS FLUSH WITH THE BOTTOM OF THE END CAP. FOR ADDITIONAL INFORMATION CONTACT STORMTECH AT 1-888-892-2694.

* FOR THE SC740EPE24B THE 24" (600 mm) STUB LIES BELOW THE BOTTOM OF THE END CAP APPROXIMATELY 1.75" (44 mm). BACKFILL MATERIAL SHALL BE REMOVED FROM BELOW THE N-12 STUB SO THAT THE FITTING SITS

NOTE: ALL DIMENSIONS ARE NOMINAL

STORMTECH SC-740 CHAMBER UNIT SYSTEM (CONTINUED) SCALE: NO SCALE

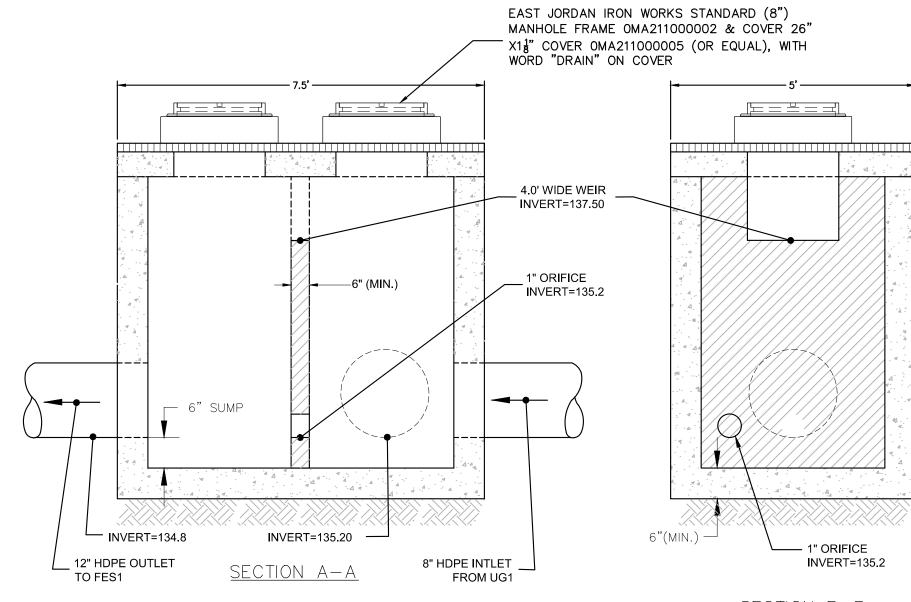


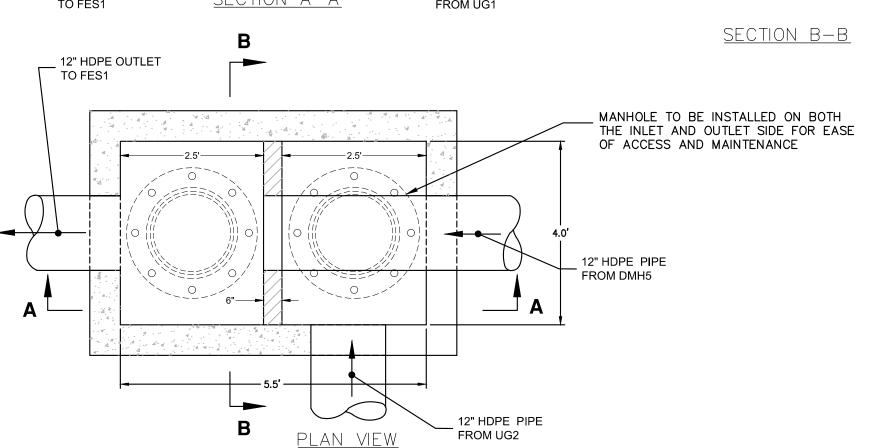

OUTLET CONTROL STRUCTURE (OCS-2) SCALE: NO SCALE

OWNER/APPLICANT:

MERHEJ & SONS REALTY, LLC **87 DERBY STREET** HINGHAM, MA 02043

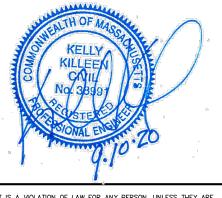

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ACTING UNDER THE DIRECTION OF A LICENSED PROFESSIONAL
ENGINEER, ARCHITECT, LANDSCAPE ARCHITECT OR LAND
SURVEYOR TO ALTER AN ITEM IN ANY WAY. IF AN ITEM BEARING
STAMP OF A LICENSED PROFESSIONAL IS ALTERED, THE ALTERI
ENGINEER, ARCHITECT, LANDSCAPE ARCHITECT OR LAND
SURVEYOR SHALL STAMP THE DOCUMENT AND INCLUDE THE
NOTATION "ALTERED BY" FOLLOWED BY THEIR SIGNATURE, THI
DATE OF SUCH ALTERATION, AND A SPECIFIC DESCRIPTION
OF THE ALTERATION.

OF THE ALTERATION.


HINGHAM GAS #19 & 27 WHITING STREET HINGHAM, MA 02043

No. Submittal / Revision App'd. By Date PERMIT SET KK JM 5/1/202 PERMIT SET KK JM 9/10/2020

SITE DETAILS

Designed By: Drawn By: Checked By DR/BN DR/BN Issue Date: Project No: 05/01/2020 060903

> Drawing No.: C-603

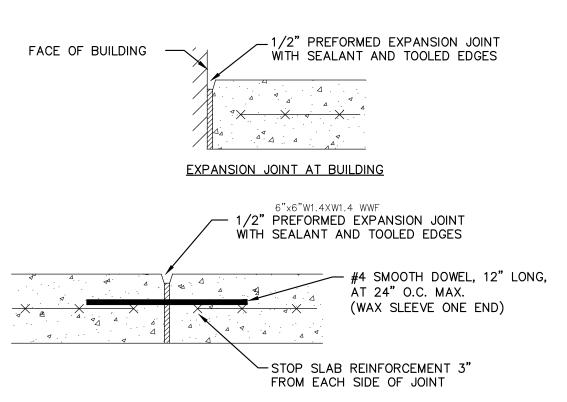

NOTE: CONCRETE SIDEWALK EXPANSION JOINT PROVIDE EXPANSION JOINTS AT ALL INTERFACES BETWEEN WALKWAY AND VERTICAL BUILDING SURFACES.

1 EXPANSION JOINT DETAIL
SCALE: NO SCALE

BUILDING FACE OR PROVIDE
CONCRETE CURB IN GRASSED
AREAS AS BACKER

PROVIDE TRUNCATED WARNING
DOMES AS REQUIRED BY ADA
ACCESSIBLE GUIDELINES FOR
BUILDINGS AND FACILITIES
(ADAAG)

1:12
4 FT
MIN.
SEE PLAN

NOTE:

ALL SIDEWALK AND RAMP CONSTRUCTION TO CONFORM TO 521 CMR

ARCHITECTURAL ACCESS BOARD AND APPLICABLE A.D.A. REGULATIONS.

ADA CURB RAMP

SCALE: NO SCALE

12' LENGTH 6' O.C. MAX. POST SPACING 6' BARN STYLE GATES MATCHING VINYL CAP & TRIM

CAP WELDED TO
TOP OF POST ELEVATION 4"x 4" VINYL POSTS 6' TALL CEDER OR VINYL PRIVACY FENCE (TAN) OR EQUAL 6' CEDER OR VINYL PRIVACY FENCE WELDED TO POST 4" DIA. SCH. 40 GALV. STEEL POSTS BRACING AS REQUIRED 12" O.C. E.W., 4,000 PSI 1" WASHED STONE,
COLOR: LIGHT GREY COLOR: LIGHT GREY ++++++++ CANE BOLT ASSEMBLY AND SLEEVE COMPACTED SUBGRADE COMPACTED GRAVEL COMPACTED SUBGRADE INTERMEDIATE POST (NO CAP) 6'0.C. AS REQUIRED SIDE ELEVATION FRONT ELEVATION CONTRACTOR TO COORDINATE FENCE CONSTRUCTION WITH MANUFACTURER'S RECOMMENDATION.

TRASH AND RECYCLING ARE WITH CONC. PAD DETAIL

SCALE: NO SCALE

GALV. STEEL FLANGED CHANNEL SIGN POST. WEIGHT: 2 LBS/FT. PUNCHED FULL LENGTH W/5/16" SHEAR BOLTS.

CONNECT BREAKAWAY HINGE PLATE TO STUB POST IN GROUND W/2 5/16" SHEAR BOLTS

FINISH GRADE, SURFACE MATERIAL MAY VARY.


CONCRETE FOOTING, 3,000 PSI

UNDISTURBED SUBGRADE


ROADWAY SIGNAGE

w/BREAKWAY SUPPORT


SCALE: NO SCALE

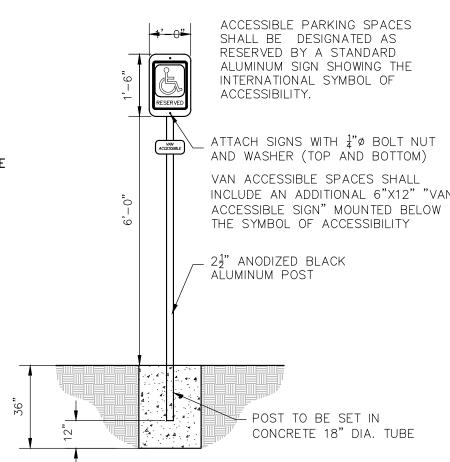


5 ACCESSIBLE PARKING SIGN DETAIL
SCALE: NO SCALE

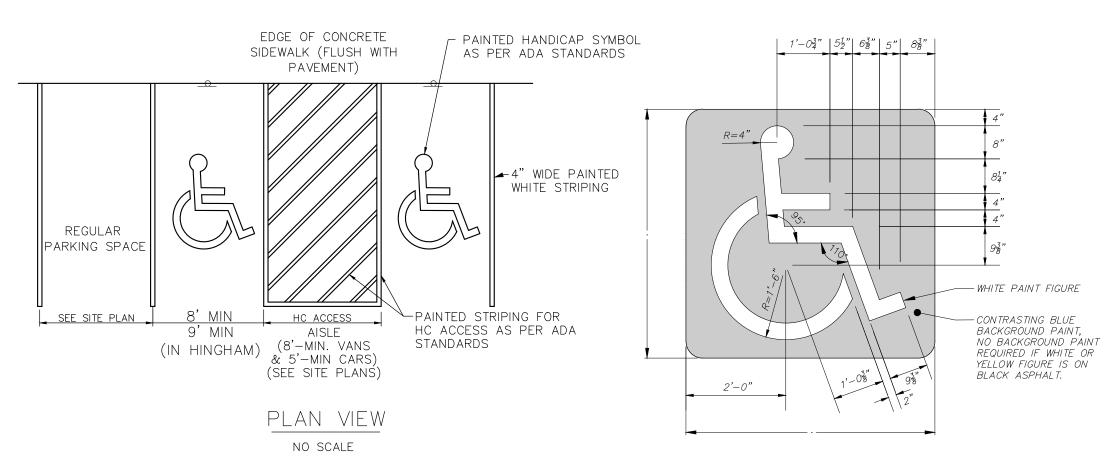

6 ACCESSIBLE STRIPING DETAIL
SCALE: NO SCALE

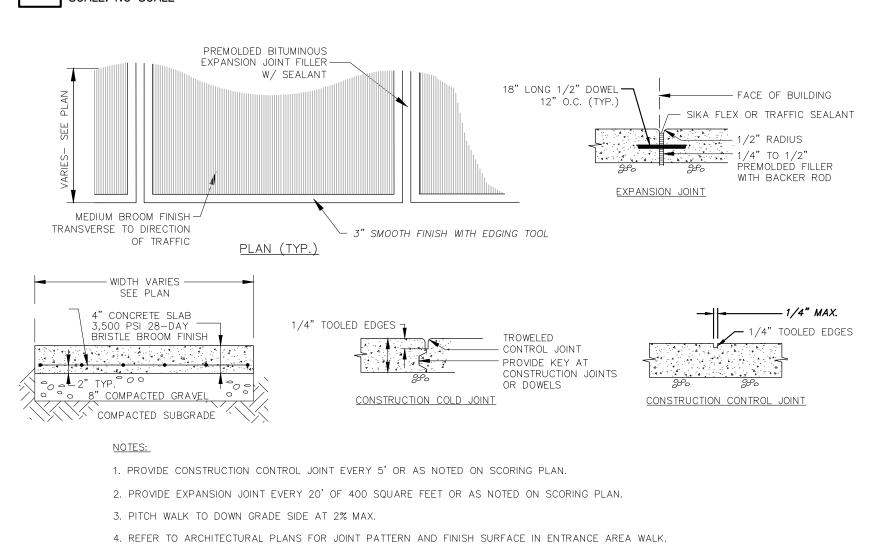

10 TYPICAL CONCRETE SIDEWALK
SCALE: NO SCALE

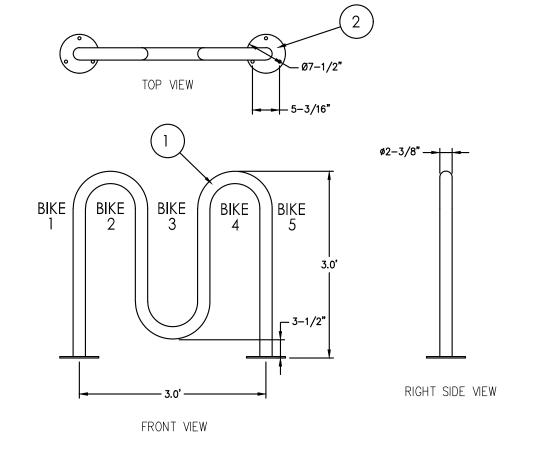


NOTES:

1. CONTRACTOR TO FOLLOW MANUFACTURERS INSTALLATION INSTRUCTIONS.

2. BIKE RACK TO BE POWDER COAT BLACK UNLESS OTHERWISE SPECIFIED.

3.1. (1) TUBING -Ø2 3/8" X .154" WALL STEEL TUBING
3.2. (2) SURFACE PLATE - Ø7 1/2" X 1/4" THICK STEEL PLATE WITH THREE 9/16" MOUNTING HOLES
3.3. (3) MOUNTED WITH SIX Ø1/2" X 4-5" STAINLESS STEEL ANCHOR BOLTS

7 5 BIKE WAVE BIKE RACK

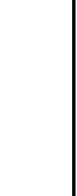

No.	Submittal / Revision	App'd.	Ву	Date
Α	PERMIT SET	KK	JM	5/1/2020
В	PERMIT SET	KK	JM	9/10/2020
		1		

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OWNER/APPLICANT:

MERHEJ & SONS

REALTY, LLC

87 DERBY STREET

HINGHAM, MA 02043

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HINGHAM GAS

#19 & 27 WHITING

STREET

HINGHAM, MA 02043

SITE DETAILS


Designed By: DR/BN	Drawn By: DR/BN	Checked By: KK
Issue Date:	Project No:	Scale:
05/01/2020	060903	

C-604

Drawing No.:

STOP SIGN R1-1

8 SIGN DETAIL
SCALE: NO SCALE

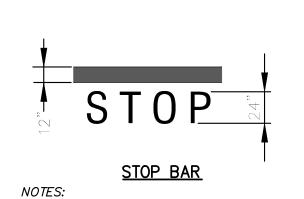

1. ALL PAINT TO BE THERMOPLASTIC.


2. WORDS CAN BE ARRANGED IN OTHER COMBINATIONS THAN THOSE ILLUSTRATED HERE TO ACHIEVE DESIRED RESULTS.

3. PAINTING OF WORDS TO BE AT THE DISCRETION OF THE OWNER. CONTRACTOR SHALL VERIFY PRIOR TO CONSTRUCTION.

9 PAINTED MARKING DETAIL
SCALE: NO SCALE

- 1. 12" VERTICAL CLEARANCE SHALL BE PROVIDED TO ANY PROPOSED OR EXISTING STRUCTURE, UTILITY OR OTHER.
- 2. 36" HORIZONTAL CLEARANCE SHALL BE PROVIDED TO ANY EXISTING OR PROPOSED STRUCTURES, UTILITIES OR OTHER.
- 3. INSPECTION AND TESTING REQUIRED BY UTILITY PROVIDER BEFORE TRENCH BACKFILL.


TYPICAL GAS UTILITY TRENCH

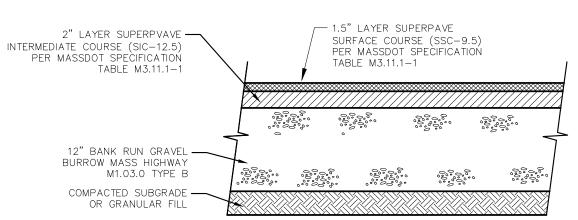


NOTES:

- 1. COMPACTED LIFTS NOT TO EXCEED 8 INCHES BETWEEN COURSES.
- 2. CONTRACTOR TO PROOF ROLL SUBGRADE PRIOR TO GRAVEL PLACEMENT.
- 3. CONTRACTOR TO CONFIRM PAVEMENT SECTION WITH GEOTECH REPORT PRIOR TO CONSTRUCTION.

BITUMINOUS PAVEMENT SECTION SCALE: NO SCALE

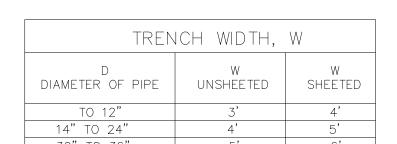


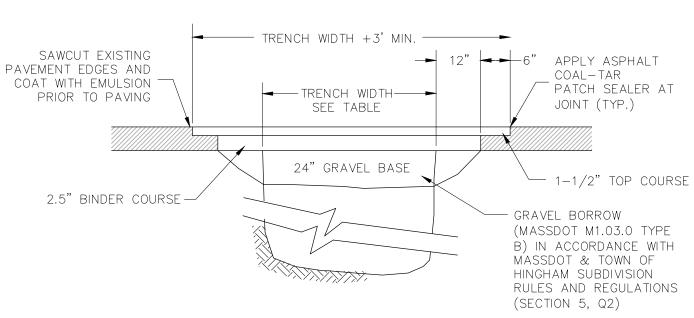

NOTES:


- 1. CONTRACTOR TO PROVIDE PAVEMENT PATCH TO MEET TOWN OF HINGHAM SUBDIVISION RULES AND PWD SPECIFICATIONS.
- 2. PAVEMENT TO BE MINIMUM 3 1/2" HOT MIX OR GREATER TO MATCH EXISTING.

PAVEMENT PATCH DETAIL FOR TRENCH SECTIONS

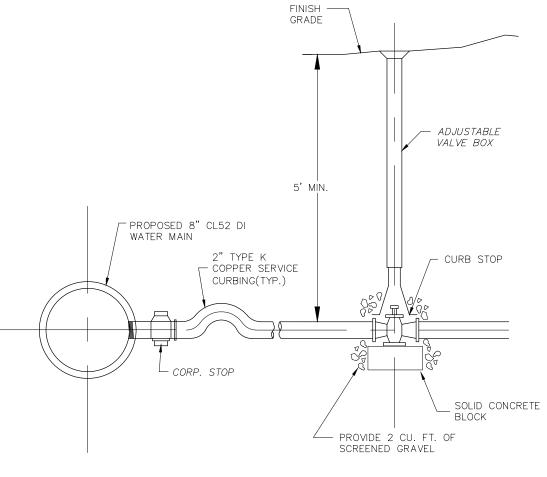


1. CONTRACTOR TO PROVIDE CATALOG CUTS OF ALL BRASS AND WATER VALVE COMPONENTS IN ACCORDANCE WITH WEIR RIVER WATER SYSTEM

WATER SERVICE DETAIL

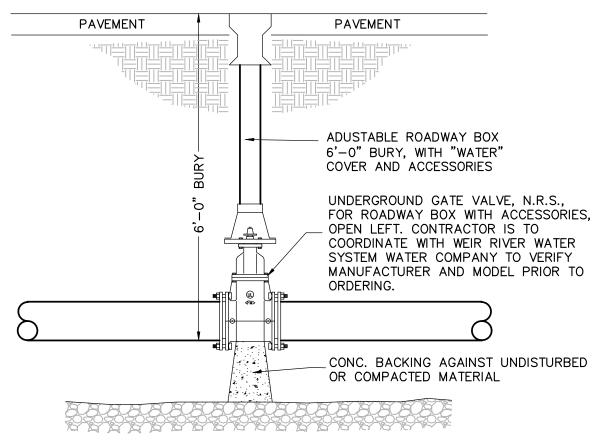


ROADWAY BOX VALVE DETAIL SCALE: NO SCALE

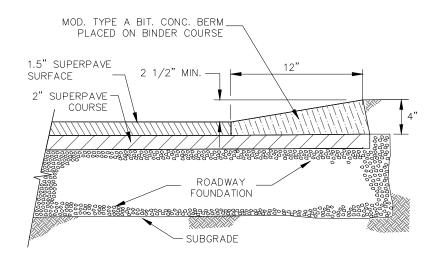


- 1. <u>Section 5, K3</u>: All hot mix asphalt must meet the massdot requirements for each mix, as submitted and approved.
- M3.12.0 BITUMINOUS CONCRETE CURB; THE BITUMINOUS CONCRETE FOR CURBING SHALL BE CLASS I CONFORMING TO THE APPLICABLE REQUIREMENTS FOR DENSE MIX (SEE TABLE A, M3.11.03).

5 CAPE COD BERM (12")
SCALE: NO SCALE

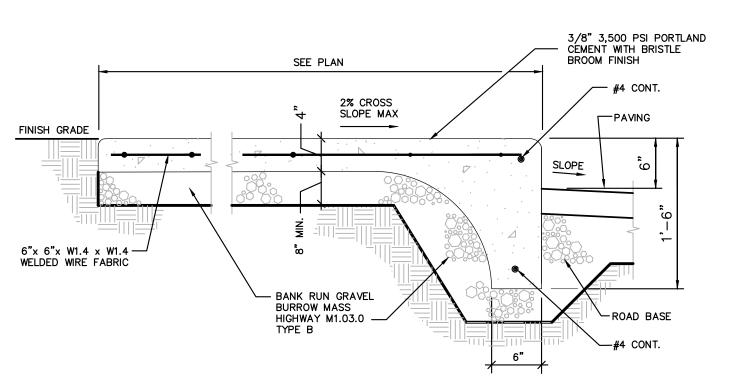


INTEGRAL WALK & CURB DETAIL (MONOLITHIC)

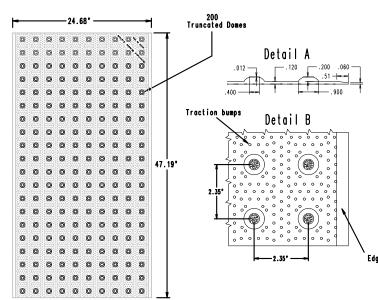

1. DETECTABLE WARNING MATS SHALL BE PROVIDED BY 'DETECTABLE WARNING SYSTEMS, INC. (866) 999-7452 WWW.DETECTABLE-WARNING.COM OR EQUAL. COLORS AVAILABLE YELLOW, BRICK RED, BLACK. CONTRACTOR TO COORDINATE COLOR WITH ARCHITECT.

- 2. DETECTABLE WARNINGS ON CURB RAMPS SHALL CONFORM TO ADAAG SECTION 4.29.2 DETECTABLE WARNINGS ON WALKWAY SURFACES.
- 3. DETECTABLE WARNINGS SHALL CONSIST OF TRUNCATED DOMES AND SHALL CONTRAST VISUALLY WITH ADJOINING SURFACES, EITHER LIGHT—ON—DARK OR DARK-ON-LIGHT.

DETECTABLE WARNINGS AT RAMPS SCALE: NO SCALE

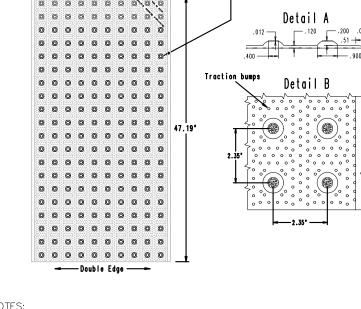

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HINGHAM GAS

#19 & 27 WHITING STREET HINGHAM, MA 02043

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OWNER/APPLICANT

MERHEJ & SONS

REALTY, LLC **87 DERBY STREET**

HINGHAM, MA 02043

No.	Submittal / Revision	App'd.	Ву	Date
Α	PERMIT SET	KK	JM	5/1/2020
В	PERMIT SET	KK	JM	9/10/2020
I				

SITE DETAILS

Designed By:	Drawn By:	Checked By:
DR/BN	DR/BN	KK
Issue Date:	Project No:	Scale:
05/01/2020	060903	

Drawing No.: C-605

6" TOPSOIL & SEED PA VED SHEETING (IF REQ"D) TO BE CUT OFF 5" MIN. BELOW GROUND & 1" MIN. ABOVE TOP OF PIPE ORDINARY BACKFILL ANY SHEETING DRIVEN 6,6,000 BELOW MID-DIA. OF PIPE SHALL BE LEFT IN PLACE FOR SEWER/FORCE MAIN TRENCH USE MIN. 3/4" SCREENED GRAVEL 6" BELOW TO 6" ABOVE PIPE CROWN EARTH W LEDGE WATER, SAN. SEWER OR DRAIN (SEE TABLE)

TRENCH WIDTH, W D W W
DIAMETER OF PIPE UNSHEETED SHEETED 3' 4' UP TO 12"

14" TO 24"

30" TO 36"

OVER WATER MAIN (IF REQUIRED)

PAVE AS SPECIFIED

- MATERIAL USED FOR BACKFILLING TO A POINT 2 FT OVER THE PIPE SHALL CONTAIN NO STONES. LARGER THAN 3 INCHES IN GREATEST DIMENSION, EXCEPT MATERIAL USED TO BACKFILL CORRUGATED PLASTIC PIPE SHALL CONSIST OF GRAVEL BORROW MEETING THE REQUIREMENTS OF M1.03.0: GRAVEL BORROW, TYPE D, TO A DEPTH OF 2 FT OVER THE TOP OF PIPE.
- BACKFILL BELOW THE HAUNCHES SHALL BE PLACED IN 6-IN. LAYERS AND COMPACTED SIMULTANEOUSLY ON BOTH SIDES OF THE PIPE WITH RAILROAD TAMPERS OR APPROVED MECHANICAL RAMMERS WHICH SHALL NOT COME IN CONTACT WITH THE PIPE. BACKFILL ABOVE THE HAUNCHES SHALL BE PLACED IN 6-IN. LAYERS AND COMPACTED AS DIRECTED. BACKFILL MATERIAL SHALL BE MOIST PRIOR TO AND DURING COMPACTION.
- BACKFILLING FOR STRUCTURAL PLATE PIPE, PIPE—ARCHES AND ARCHES SHALL BE PLACED EVENLY ON BOTH SIDES OF THE STRUCTURE IN LAYERS NOT EXCEEDING 6 IN. IN DEPTH. BACKFILLING SHALL BE PLACED UNIFORMLY ON BOTH SIDES OF PIPE. THE FILL MATERIAL SHALL BE THOROUGHLY TAMPED AROUND THE PIPE OR PIPE-ARCH, BETWEEN THE PIPE OR PIPE-ARCH AND THE SIDES OF THE TRENCH, OR FOR A MINIMUM DISTANCE EACH SIDE OF THE PIPE OR PIPE-ARCH EQUAL TO THE DIAMETER OR SPAN OF THE STRUCTURE.
- IN ALL CASES THE FILLING MATERIAL SHALL BE THOROUGHLY TAMPED.
- REMOVE UNSUITABLE MATERIAL BELOW GRADE, IF ENCOUNTERED, TO SUITABLE DEPTHS AS DIRECTED BY ENGINEER AND REPLACE WITH CLEAN GRANULAR FILL AND FILTER FABRIC.

NOTES:


1. ALL TRENCH CONSTRUCTION TO CONFORM TO APPLICABLE FEDERAL, STATE AND LOCAL REGULATIONS. 2. COMPACT FILL AND TAMP PIPE TO 95% MAX. DRY DENSITY IN 8" LIFTS UNLESS OTHERWISE SPECIFIED.

4' 5'

5' 6'

- 3. INSTALL DUCTILE IRON WATER PIPE IN ACCORDANCE WITH ANSI A21.51 (AWWA C151) LAYING CONDITION
- 4. MATERIALS FOR SEWER BEDDING, HAUNCHING, AND BACKFILL TO CONFORM TO CLASSES I, II, OR III AS DESCRIBED IN ASTM D 2321 AND TR-16 GUIDES FOR THE DESIGN OF WASTEWATER TREATMENT WORKS.
- 5. PROVIDE MINIMUM 5 FT. COVER OVER WATER MAIN AS MEASURED FROM BOTTOM OF CURB LINE. INSULATE WATERMAIN IN ACCORDANCE WITH M.H.D. SECTION 301 WATER SYSTEMS IN AREAS PRONE TO FROST ACTION AND/OR LESS THAN 5' MINIMUM COVER.

TYPICAL TRENCH SECTION

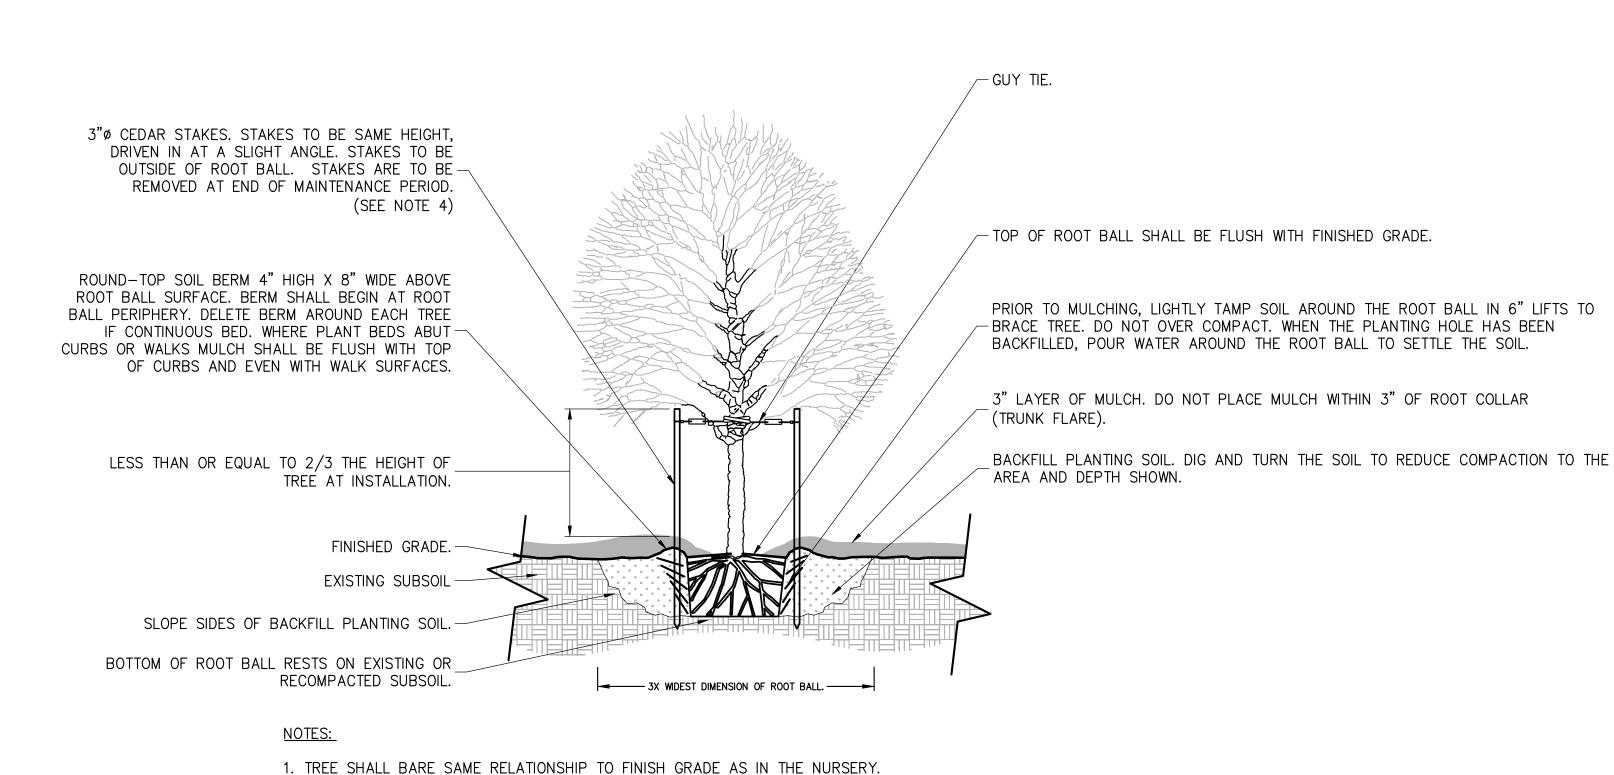

UPDATE AND USE IF NOT USING SPECIFICATIONS

1. EDGING: STANDARD-PROFILE EXTRUDED-ALUMINUM EDGING, ASTM B221 (ASTM B221M), ALLOY 6063-T6, FABRICATED IN STANDARD LENGTHS WITH INTERLOCKING SECTIONS WITH LOOPS STAMPED FROM FACE OF SECTIONS TO RECEIVE STAKES.

- 2. EDGING SIZE: 3/16 INCH WIDE BY 5-1/2 INCHES DEEP.
- 3. STAKES: ALUMINUM, ASTM B221 (ASTM B221M), ALLOY 6061-T6, APPROXIMATELY 1-1/2 INCHES WIDE BY 12 INCHES LONG.
- 4. FINISH BLACK ANODIZED.
- 5. PAINT COLOR: BLACK.
- 6. MANUFACTURERS: PROVIDE PRODUCTS BY ONE OF THE FOLLOWING OR APPROVED EQUAL:
 - 6.1. CURVE-RITE ALUMINUM EDGINGS.
 - 6.2. PERMALOC ALUMINUM EDGING.
 - 6.3. RUSSELL, J.D. COMPANY (THE). 6.4. SURE-LOC ALUMINUM EDGING CORPORATION.

<u> ANDSCAPE EDGING</u> NOT TO SCALE

— LANDSCAPE EDGING (SEE NOTES) PLANTING BED MEDIA COMPACT GRADE ADJACENT TO EDGING TO AVOID SETTLING -12" ALUMINUM STAKES

— TOP OF EDGING TO BE

SURFACE MATÉRIAL

MAXIMUM OF 1/2" ABOVE

OWNER/APPLICANT:

MERHEJ & SONS REALTY, LLC

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OF THE ALTERATION.


HINGHAM GAS #19 & 27 WHITING STREET HINGHAM, MA 02043

No. Submittal / Revision App'd. By Date PERMIT SET NJS JK 5/1/202 PERMIT SET NJS | JK | 9/10/2020

SITE DETAILS

Designed By: Drawn By: Checked B Issue Date: Project No: 05/01/2020 060903

> Drawing No.: C-606

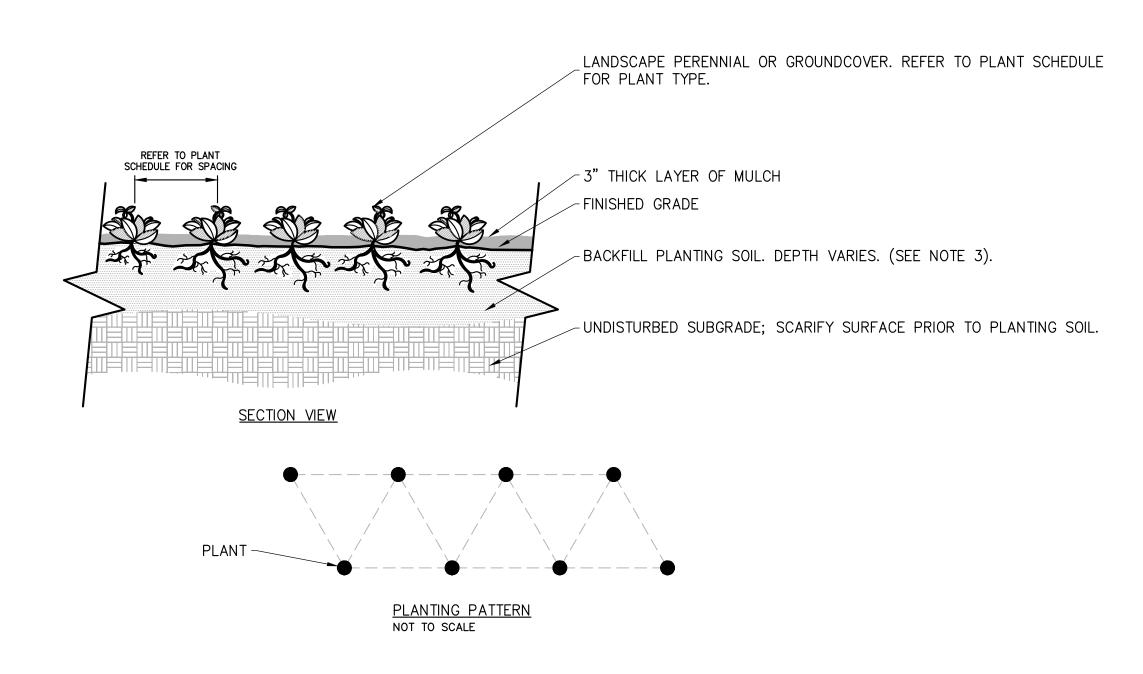

- 1. SEE PLANTING SCHEDULE FOR GROUNDCOVER AND PERENNIAL SPECIES, SIZE, AND SPACING DIMENSION.
- 2. SETTLE SOIL AROUND ROOT BALL OF EACH GROUNDCOVER AND
- PERENNIAL PRIOR TO MULCHING.
- 3. PLANTING SOIL DEPTH FOR PERENNIALS SHALL BE A MINIMUM OF 12" FOR PERENNIALS AND 6" FOR GROUNDCOVERS.

2. PRUNE ANY BROKEN BRANCHES AFTER FINAL PLACEMENT. PRUNE PERIMETER BRANCHES AS REQUIRED BUT RETAIN NATURAL SHAPE OF TREE. NEVER CUT A

LEADER. PRUNING TO BE PERFORMED BY A QUALIFIED LANDSCAPE

4. TREES 2 1/2" CAL. OR GREATER SHALL BE GUYED AND STAKED WITH 3

5. AFTER PLACEMENT AND ROTATION OF TREE, REMOVE ALL ROPES FROM ROOT BALL AND CUT AND REMOVE TOP HALF OF BURLAP. COMPLETELY REMOVE

DECIDUOUS TREE PLANTING & STAKING

PROFESSIONAL.

3. TREE SHALL BE PLUMB AND STRAIGHT.

BURLAP IF IT IS MADE OF SYNTHETIC MATERIAL.

EQUALLY SPACED STAKES.

NOT TO SCALE

GROUNDCOVER/PERENNIAL PLANTING

4" HIGH X 8" WIDE ROUND - TOP SOIL BERM ABOVE ROOT BALL SURFACE. BERM SHALL BEGIN -AT ROOT BALL PERIPHERY. (SEE NOTE 3) -FINAL GROUND LINE SAME AS NURSERY. 3" SHREDDED HARDWOOD MULCH. --FINISHED GRADE -SLOPE SIDES OF LOOSENED SOIL. PRIOR TO MULCHING, LIGHTLY TAMP SOIL AROUND THE ROOT BALL IN 6" LIFTS TO BRACE SHRUB. DO NOT OVER COMPACT. WHEN THE PLANTING-HOLE HAS BEEN BACKFILLED, POUR WATER AROUND THE ROOT BALL TO SETTLE THE SOIL. ROOT BALL RESTS ON EXISTING OR RECOMPACTED SUBSOIL. BACKFILL PLANTING SOIL. 3 X'S WIDEST DIMENSION OF ROOT BALL - EXISTING SUBSOIL.

- 1. MIX PLANTING SOIL IN PLANTING HOLES OR CONTINUOUS BEDSAFTER PLACEMENT AND ROTATION OF SHRUB REMOVE ALL ROPES FROM ROOT BALL AND CUT AND REMOVE TOP OF BURLAP.
- 2. DELETE SOIL BERM AROUND EACH SHRUB IF CONTINUOUS BED. PROVIDE NEAT TRIMMED SOIL EDGE AT CONTINUOUS BEDS AGAINST LAWN. WHERE PLANT BEDS ABUT CURBS OR WALKS MULCH SHOULD BE FLUSH WITH TOP OF CURBS AND EVEN WITH WALK SURFACES.
- 3. PRUNE BROKEN CANES AFTER PLANTING.

SHRUB PLANTING

SEPTIC SYSTEM SIZING INFORMATION AND DESIGN DATA

- FOR RETAIL, (50 GPD/ 1,000 S.F.) IS USED, AND FOR GAS ISLAND, (75 GPD/ ISLAND) IS USED BASED ON TITLE 5 (310CMR 15.203).
- TOTAL FLOW RATE REQUIRED FOR THE FACILITY, BASED ON SIZE OF RETAIL AREA AND NUMBER OF GAS ISLANDS: (3,531 S.F.) X (50 GPD/ 1,000 S.F.) = 176.2 GPD (3 GAS ISLANDS) X (75 GPD/ GAS ISLAND) = 225 GPD
- THE PROPOSED DESIGN FLOW 401.2 GPD.

DESIGN FLOW FACTOR OF SAFETY= (401.2 GPD/401.2 GPD)= 1.00

(176.2 GPD) + (225 GPD) = 401.2 GPD

ONE TWO CHAMBER SEPTIC TANK IS PROPOSED FOR THE NEW FACILITY: THE FIRST CHAMBER OF THE SEPTIC TANK IS SIZED FOR OVER 200% OF THE DAILY DESIGN FLOW AT 1,000 GALLONS. THE SECOND CHAMBER OF THE SEPTIC TANK IS SIZED FOR OVER 100% OF THE DAILY DESIGN FLOW AT 500 GALLONS.

LIST OF LOCAL VARIANCES REQUIRED (TOWN OF HINGHAM BOH RULES & REGULATIONS)


NONE

SOIL ABSORPTION SYSTEM SIZING INFORMATION:

- SOIL ABSORPTION SYSTEM (SAS) SHALL BE EXCAVATED PRIOR TO BUILDING CONSTRUCTION
- DESIGN FLOW = 401.2 GPD
- PER 310CMR, SECTION 15.242, LOADING RATE FOR CLASS I (<5 MIN/INCH) SOILS IS =0.74 GPD/SF

CONTROLLING SEASONAL HIGH GROUNDWATER ELEVATION IS WITHIN TEST PIT (TP4), WHICH RESULTS IN AN ESTIMATED SEASONAL HIGH GROUNDWATER (ESHGW) ELEVATION OF 134.18 (REDOXIMORPHIC FEATURES AT 83" FROM TOP OF TP-4).


- THE SYSTEM HAS BEEN DESIGNED TO COMPLY WITH SECTION VII.J OF THE HINGHAM SUPPLEMENTARY RULES AND REGULATIONS TO PROVIDE AT LEAST 6 FEET OF NATURALLY OCCURRING PERMEABLE MATERIAL BELOW THE BOTTOM OF THE SYSTEM TO THE ESHGW FOR SOILS WITH PERCOLATION RATES BETWEEN 2 MINUTES AND 5 MINUTES PER INCH.
- USE LEACHING BED IN ACCORDANCE WITH 310CMR 15.252 WERE SELECTED
- REQUIRED AREA = (401.2 GPD/0.74 GPD/SF) = 542.2 SF
- USE 31 FT LONG X 20 FT WIDE BED::
- LEACHING BED PROVIDED DAILY CAPACITY= (31 FEET LONG) X (20 FEET WIDE) X (0.74 GPD/SF)= 458.8 GPD > 401.6 GPD O.K.

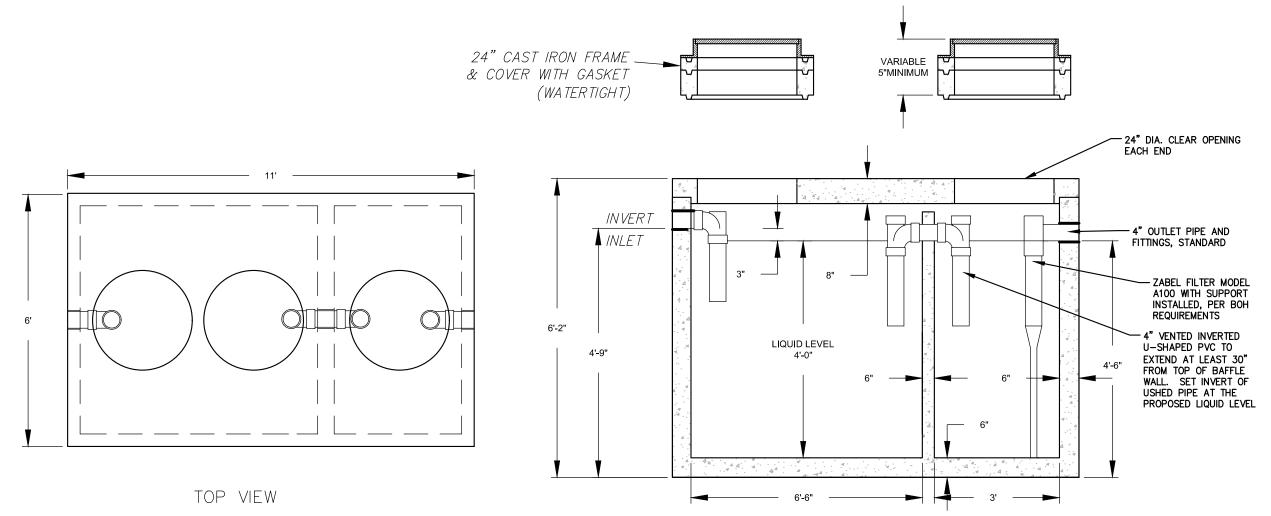


NOTES

- CROSS SECTION
- PROPERLY SIZED SEPTIC TANK SHALL CONFORM TO ALL TITLE 5 AND HINGHAM BOH REQUIREMENTS.
 ALL TANK PENETRATIONS SHALL BE CORED IN FIELD, AFTER TANKS ARE SET IN THE GROUND AND PRIOR TO BACKFILLING.
- 3. STRUCTURE SHALL BE WATERTIGHT.
 4. SEPTIC TANK TO WITHSTAND H-20 LO.
- . SEPTIC TANK TO WITHSTAND H—20 LOADING. . INLET TEE TO EXTEND A MINIMUM OF 10" BELOW FLOW LINE.
- 6. PROVIDE A MINIMUM 3" SPACE BETWEEN INLET AND FLOW LINE.
- 7. SEAL ALL JOINTS WITH ARE DAGED AND STATE TRANSPORTS BROWNERS BROWNERS AND THE STATE OF STATE AND THE STATE OF STATE O
- 8. DIMENSIONS SHOWN HEREIN ARE BASED ON SCITUATE CONCRETE PRODUCTS. PRODUCT. AN EQUAL PRODUCT CAN BE USED IF THE MINIMUM CAPACITY OF THE TANK IS 1,500 GALLONS WITH A BAFFLE.
- 9. A MIN. 24" DIA. MANHOLE FRAME & COVER TO GRADE OVER THE INLET AND OUTLET SHALL BE PROVIDED.
 10. SHOP DRAWING SUBMITTALS SHALL INCLUDE BUOYANCY CALCULATIONS AND CONTRACTOR IS RESPONSIBLE FOR SUITABLE STRUCTURES TO RESIST BUOYANCY. ASSUME TANK
- SUBMERGED UP TO FEMA FLOOR PLAIN ELEVATION. (10.0 NAVD)
- 11. COVERS SHALL BE CAM LOCK WATERTIGHT COVERS OR APPROVED EQUAL.

1 1,500 GALLON SEPTIC TANK WITH BAFFLE SCALE: NO SCALE

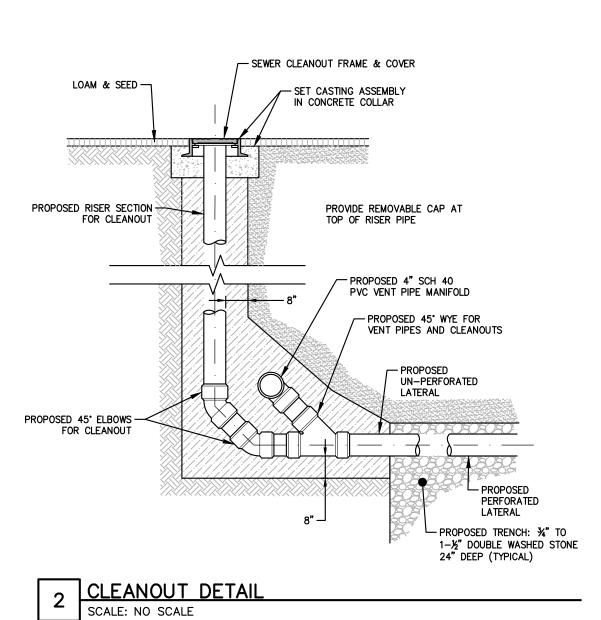


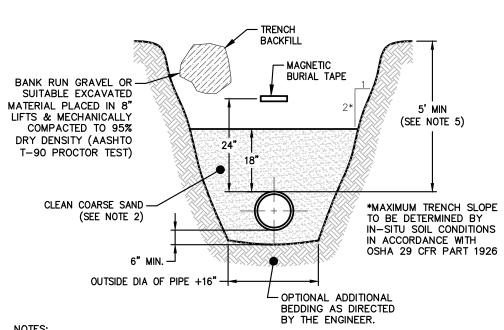

- NOTES:

 1. NO DEBRIS, FROZEN MATERIAL, LARGE CLODS, STONES OR ORGANIC MATERIAL SHALL BE PLACED IN TRENCH BACKFILL. TRENCH BACKFILL SHALL CONSIST OF SUITABLE EXCAVATED MATERIAL OR OTHER APPROVED MATERIAL.
- 2. CLEAN COARSE SAND PASSING 1/4" SIEVE. EFFECTIVE GRAIN SIZE SHALL BE BETWEEN 0.3 TO 0.6 MM AND THE UNIFORMITY COEFFICIENT SHALL BE 3.5 OR LESS.
- TO 0.6 MM AND THE UNIFORMITY COEFFICIENT SHALL BE 3.5 OR LESS.

 3. BURIAL TAPE MARKED "CAUTION BURIED SEWER BELOW" OVER SEWER MAIN. TRACER WIRE
- 4. CONTRACTOR TO PROVIDE AS—BUILT LOCATION OF ALL FORCE MAIN AND SEPTIC TANK EFFULENT COMPONENTS.
- 5. IN AREAS SUBJECT TO FROST OR < 5 FT. COVER, PROVIDE PIPE INSULATION.
- TYPICAL TRENCH DETAIL FOR PRESSURE FORCE MAIN
 SCALE: NO SCALE

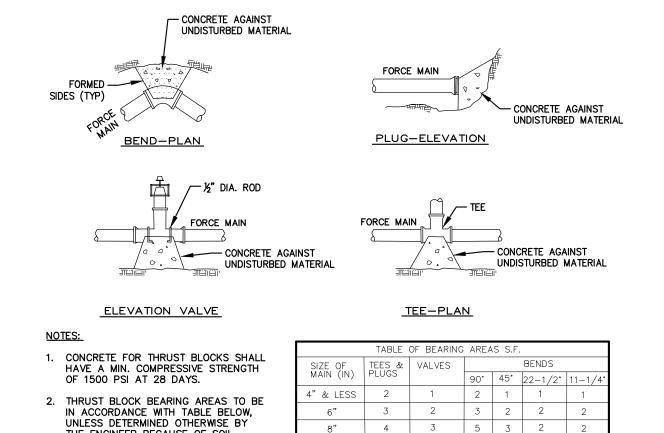


0" & 12" 9 4 10 6 4


THE ENGINEER BECAUSE OF SOIL

THRUST BLOCK DETAILS

CONDITIONS.

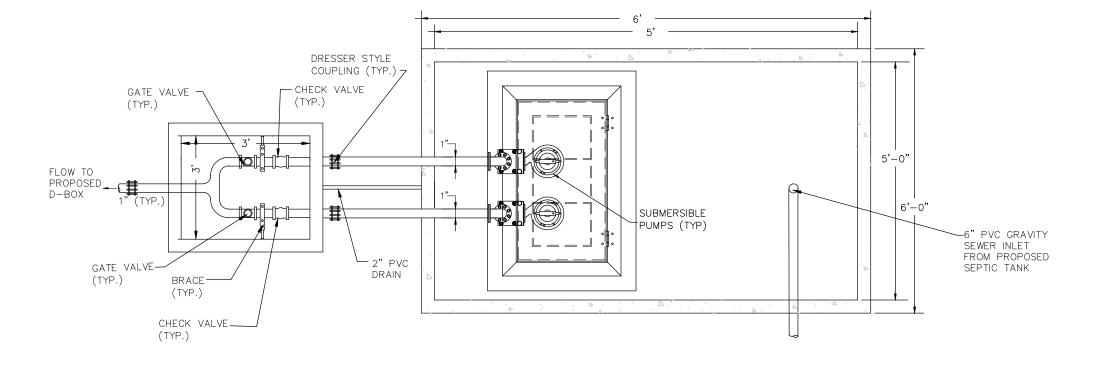

<u>PUMP CHAMBER AND VALVE CHAMBER</u> PLAN VIEW

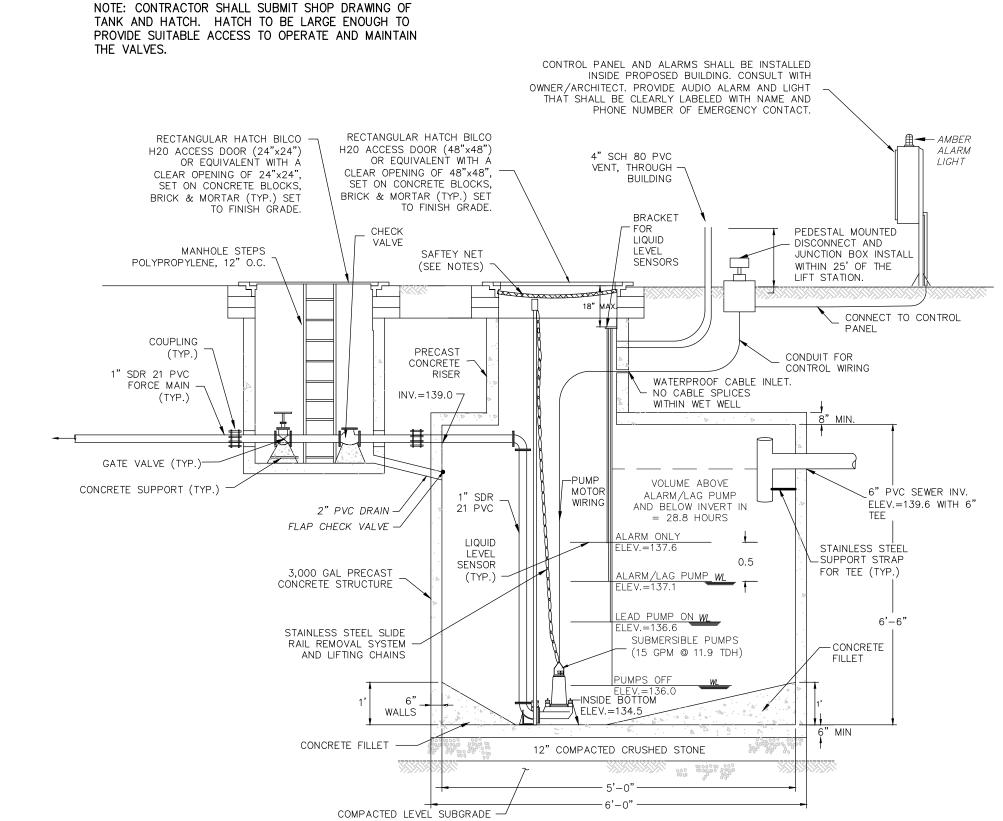

PUMP CHAMBER AND VALVE CHAMBER ELEVATION VIEW

- 1. PUMP EQUIPMENT SHALL BE DUPLEX SUBMERSIBLE PUMPS AS MANUFACTURED. THE UNITS SHALL OPERATE FROM A 230 VOLT, 1 PHASE, 3 WIRE A.C. POWER SOURCE. PUMPS SHALL BE APPROVED BY CHA BEFORE INSTALLATION.
- 2. PUMP STATION WET WELLS AND VALVE CHAMBERS SHALL BE PROVIDED BY THE CONTRACTOR AND SHALL BE STANDARD H20 LOADING, CONSTRUCTED OF REINFORCED CONCRETE FOR COMPRESSIVE STRENGTH TO A MINIMUM OF 5,000 PSI AND TO THE DIMENSIONS AS SHOWN ON THE DETAILS AND MANUFACTURED BY ROTONDO & SONS, REHOBOTH, MA, OR APPROVED EQUAL.
- 3. ALL STEEL REINFORCEMENT SHALL CONFORM TO ASTM A 615-75 GRADE 60 WITH 1" MINIMUM COVER.
- 4. THE SUBMERSIBLE PUMPS SHALL BE INSTALLED WITH A HYDRAULICALLY SEALED SLIDE COUPLING ARRANGEMENT SO THAT THE PUMPS CAN BE REMOVED FROM THE WET WELL FOR SERVICE AND INSPECTION AND THEN RETURNED TO SERVICE WITHOUT ENTERING THE WET WELL BASIN TO UNBOLT OR UNLOCK THE CONNECTION BETWEEN THE PUMP AND PIPING.
- 5. THE ACCESS COVERS SHALL EXTEND TO FINISH GRADE. THE ACCESS COVERS SHALL BE GALVANIZED STEEL DOOR TO THE CLEAR DIMENSIONS AS SHOWN ON THE DETAILS DESIGNED FOR HS-20 WHEEL LOADING PLUS ADDITIONAL 30% LIVE LOAD. THE ACCESS COVERS SHALL HAVE STAINLESS STEEL HINGES WITH STAINLESS STEEL PINS, A FLUSH SPRING LOADED SNAP LOCK OPERABLE FROM THE OUTSIDE BY A REMOVABLE HANDLE AND FROM THE INSIDE BY A FIXED HANDLE, AND SURFACE MOUNTED PADLOCK.
- EACH SUBMERSIBLE PUMP SHALL BE EQUIPPED WITH 60 FEET OF POWER CABLE WITH EPOXY SEALED HOUSING WITH SECONDARY PRESSURE GROMMET FOR SEALING AND STRAIN RELIEF. ALL INCOMING LEAD WIRES SHALL BE SPLICED IN THE MOTOR TERMINAL HOUSING.
 THE CONTRACTOR SHALL FURNISH AND INSTALL FOUR (4) LIQUID LEVEL SENSORS WITH SUFFICIENT LENGTH OF CABLE FOR EACH PUMP STATION.
- SUSPENDED TYPE OF LEVEL SENSORS MOUNTED IN A CORROSION RESISTANT POLYPROPYLENE HOUSING, AND MOUNTED TO TANK INTERIOR BY A DETACHABLE BRACKET.
- 8. ELECTRICAL SUPPLY AND CONTROL CIRCUITS SHALL BE DESIGNED TO ALLOW DISCONNECTION AT PEDESTAL MOUNTED WATERTIGHT JUNCTION BOX LOCATED ADJACENT TO THE PUMP STATION. SUPPLY AND CONTROL WIRING SHALL BE PLACED IN SEPARATE CONDUIT.
- 9. THE PUMP MOTORS SHALL MEET THE REQUIREMENTS OF THE NATIONAL ELECTRICAL CODE FOR CLASS 1, DIVISION 2 LOCATIONS.
- 10. ALL INLET AND OUTLET PIPING CONNECTIONS AT THE WET WELLS AND VALVE CHAMBERS SHALL BE MADE WATERTIGHT.


 11. DISCHARGE PIPING WITHIN WET WELLS AND VALVE CHAMBERS SHALL BE PVC, SCHEDULE 40. PIPING BEYOND VALVE CHAMBERS SHALL BE PVC, SDR 21.
- 12. CONTRACTOR SHALL VERIFY EXISTING, AVAILABLE POWER LOCATION AND PHASE ETC. PRIOR TO ORDERING AND INSTALLING PUMPS.
- 13. PUMP CHAMBER SHALL BE FITTED WITH A SAFETY NET MANUFACTURED BY "SAFE APPROACH" OR APPROVED EQUAL. CONTRACTOR SHALL VERIFY SAFETY NET SPECIFICATIONS WITH THE PEMBROKE BOARD OF HEALTH.
- 14. STAINLESS STEEL SHALL BE USED FOR BRACKETS, RAILS, LIFTING CHAINS AND SAFETY NET BRACKETS.
- 15. PROVIDE THRUST BLOCKING FOR ALL FITTINGS AND BENDS ETC. IN THE FORCEMAIN.

5 DUPLEX PUMP CHAMBER AND VALVE CHAMBER (H2O)
SCALE: NO SCALE



OWNER/APPLICANT:

MERHEJ & SONS REALTY, LLC 87 DERBY STREET HINGHAM, MA 02043

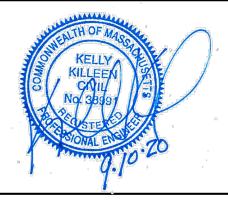

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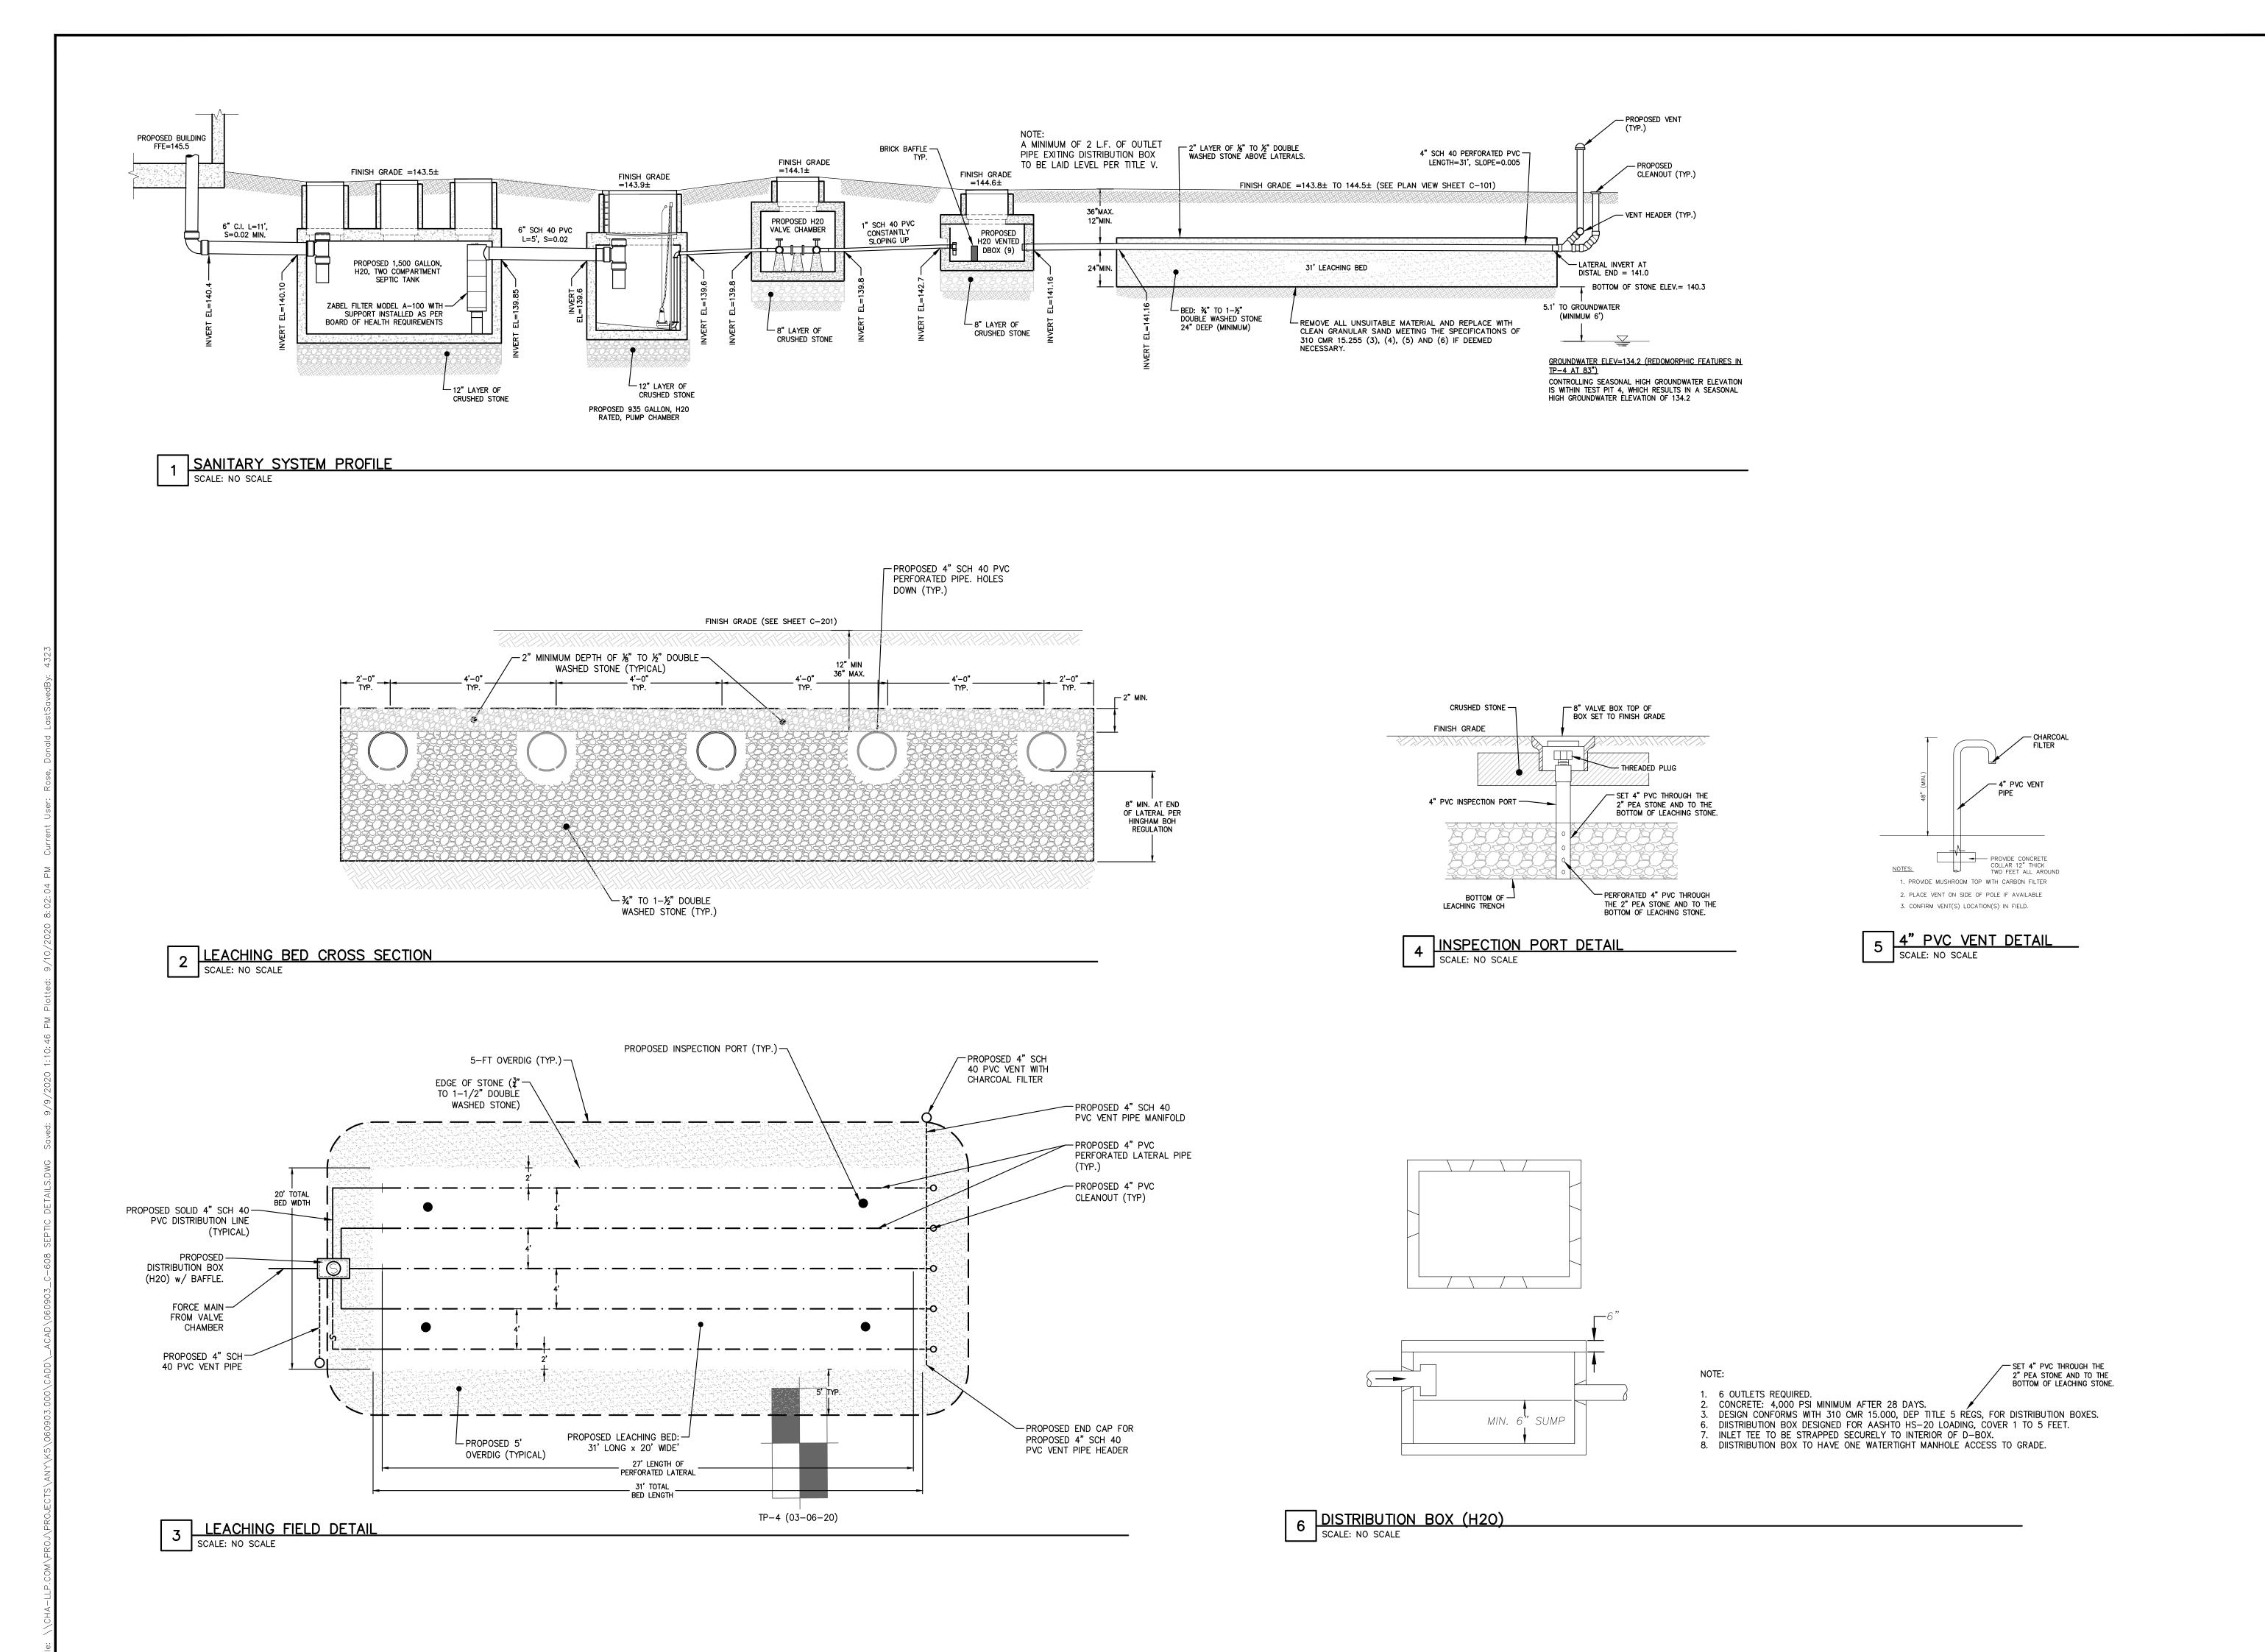
HINGHAM GAS #19 & 27 WHITING STREET HINGHAM, MA 02043

No.	Submittal / Revision	App'd.	Ву	Date
Α	PERMIT SET	KK	JM	5/1/2020
В	PERMIT SET	KK	JM	9/10/2020

SEPTIC DETAILS - 1

Designed By:	Drawn By:	Checked By
DR/BN	DR/BN	KK
Issue Date:	Project No:	Scale:
05/01/2020	060903	

Drawing No.:




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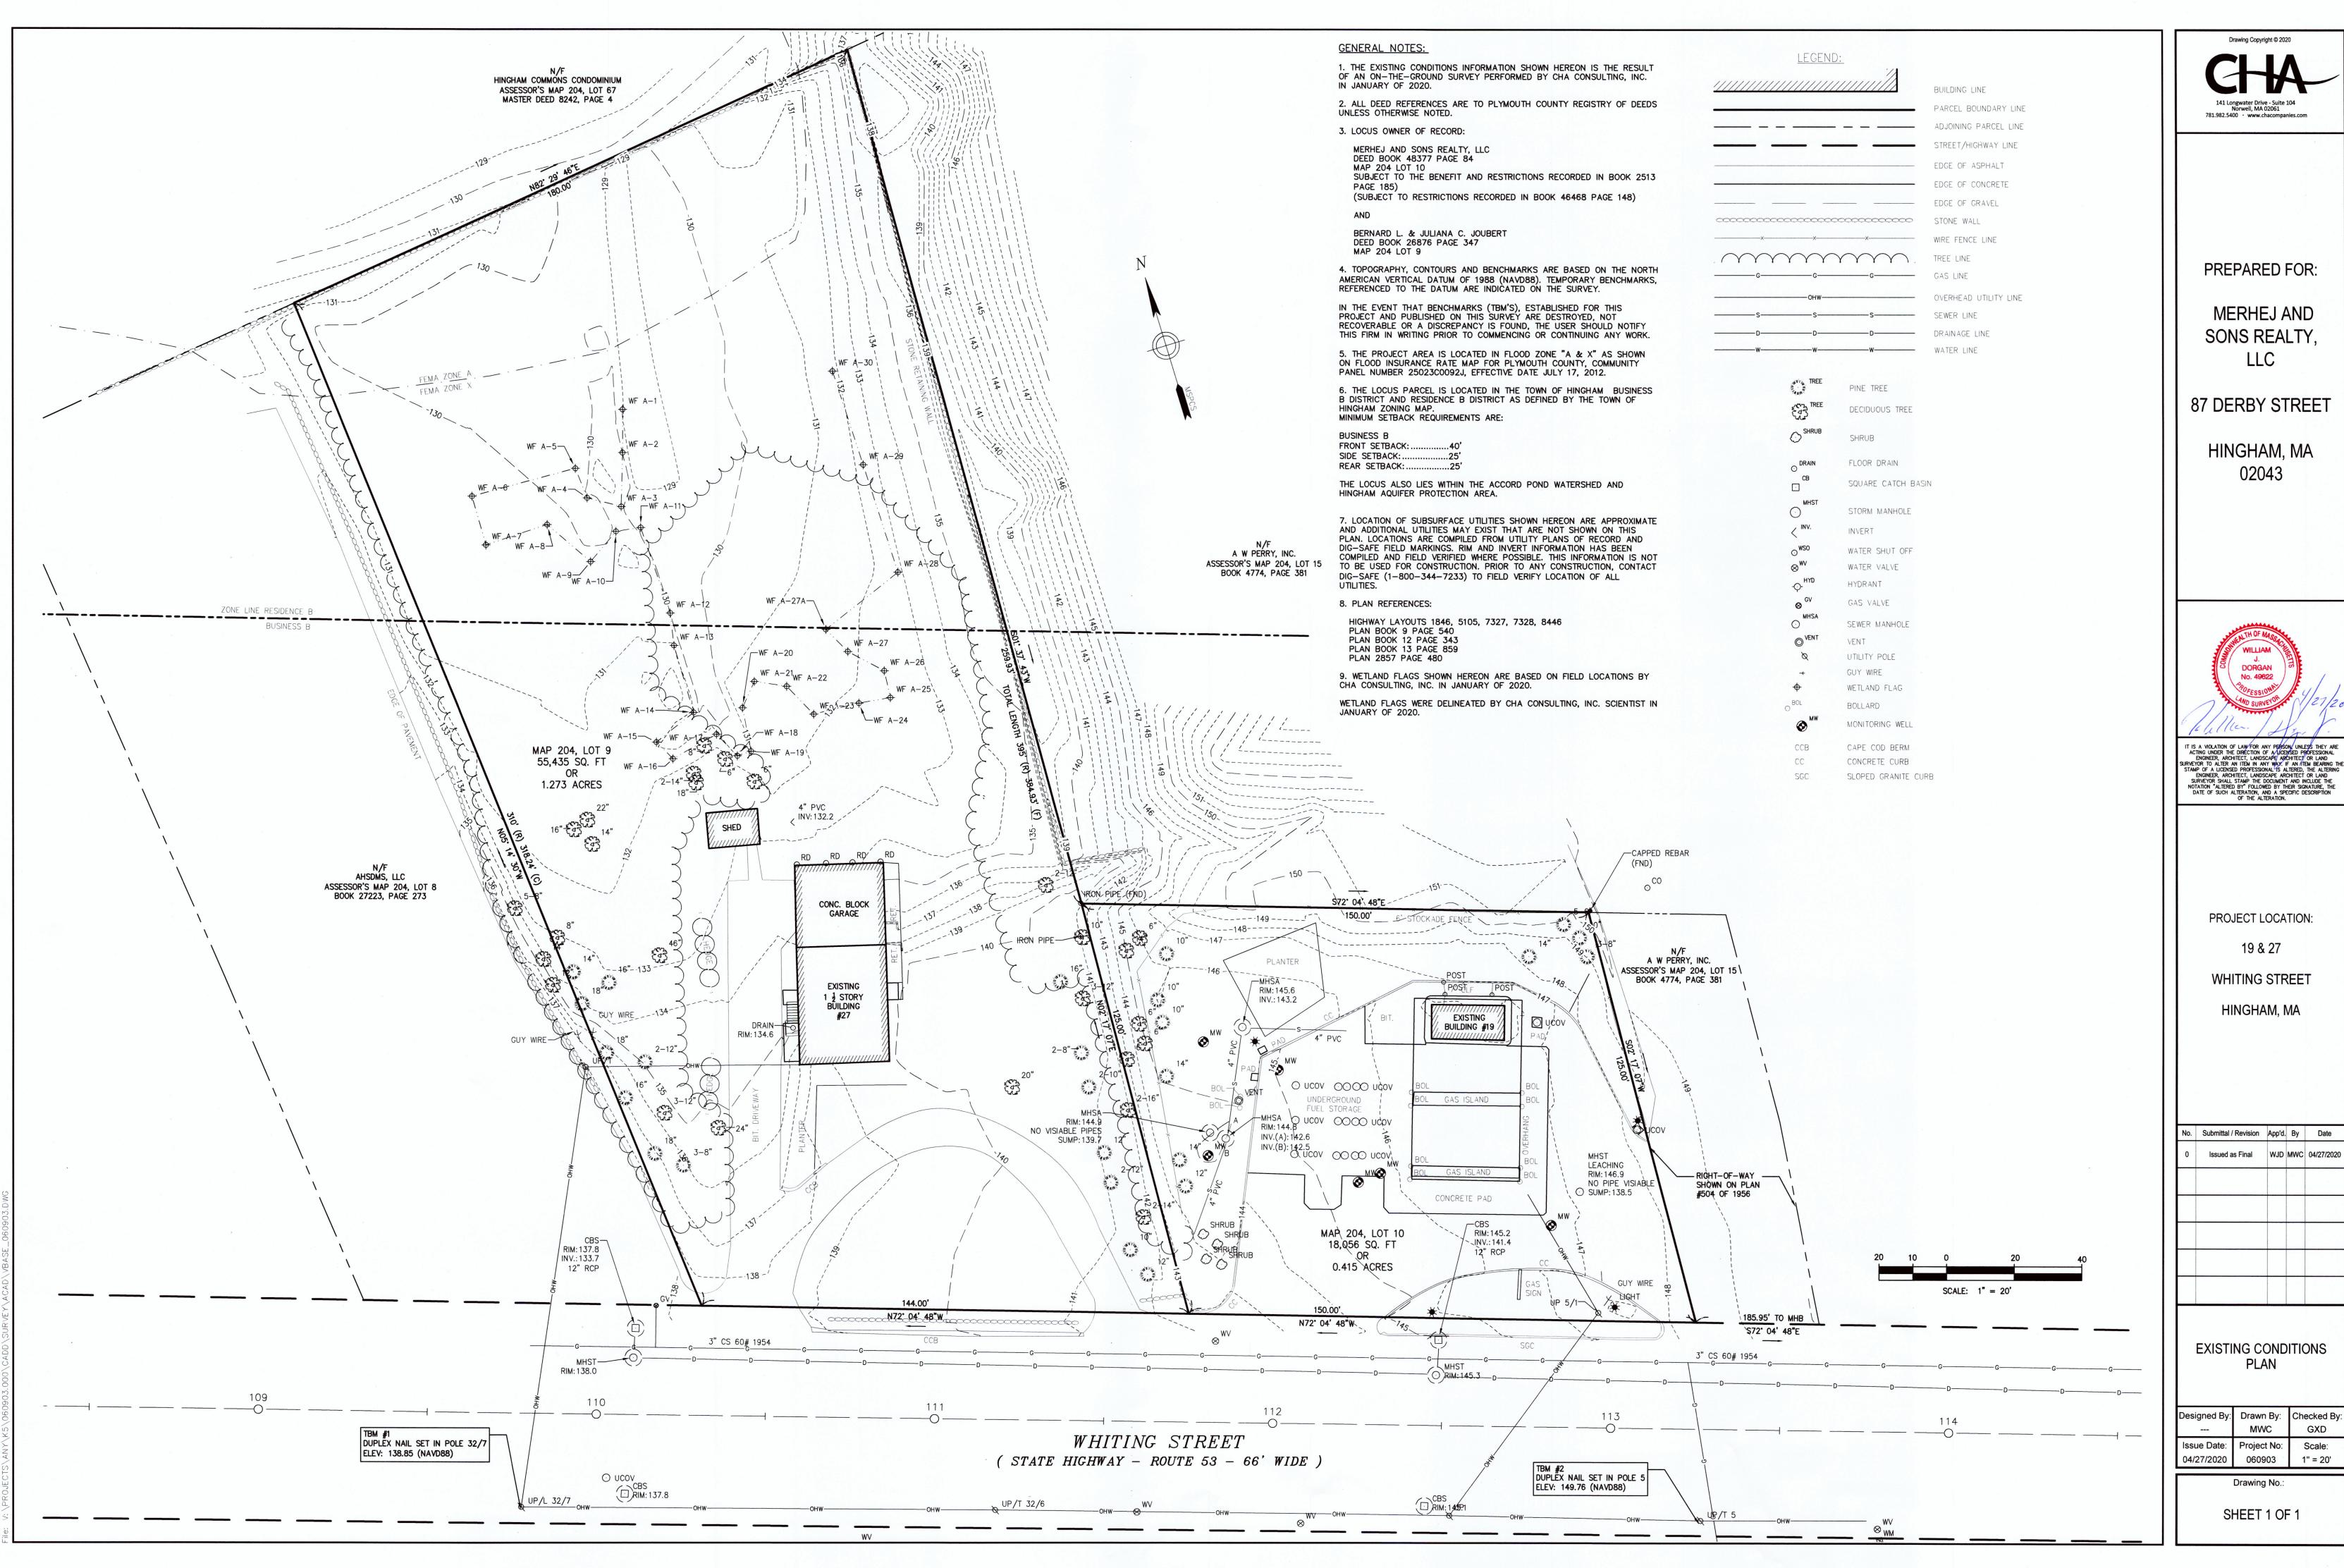
IT IS A VIOLATION OF LAW FOR ANY PERSON, UNLESS THEY ARE ACTING UNDER THE DIRECTION OF A LICENSED PROFESSIONAL ENGINEER, ARCHITECT, LANDSCAPE ARCHITECT OR LAND SURVEYOR TO ALTER AN ITEM IN ANY WAY. IF AN ITEM BEARING TH STAMP OF A LICENSED PROFESSIONAL IS ALTERED, THE ALTERING ENGINEER, ARCHITECT, LANDSCAPE ARCHITECT OR LAND SURVEYOR SHALL STAMP THE DOCUMENT AND INCLUDE THE NOTATION "ALTERED BY" FOLLOWED BY THEIR SIGNATURE, THE DATE OF SUCH ALTERATION, AND A SPECIFIC DESCRIPTION OF THE ALTERATION.


HINGHAM GAS #19 & 27 WHITING STREET HINGHAM, MA 02043

√o.	Submittal / Revision	App'd.	Ву	Date
Α	PERMIT SET	KK	JM	5/1/2020
В	PERMIT SET	KK	JM	9/10/2020

SEPTIC DETAILS - 2

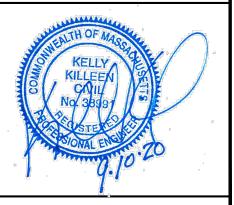Designed By:	Drawn By:	Checked By:
DR/BN	DR/BN	KK
Issue Date:	Project No:	Scale:
05/01/2020	060903	



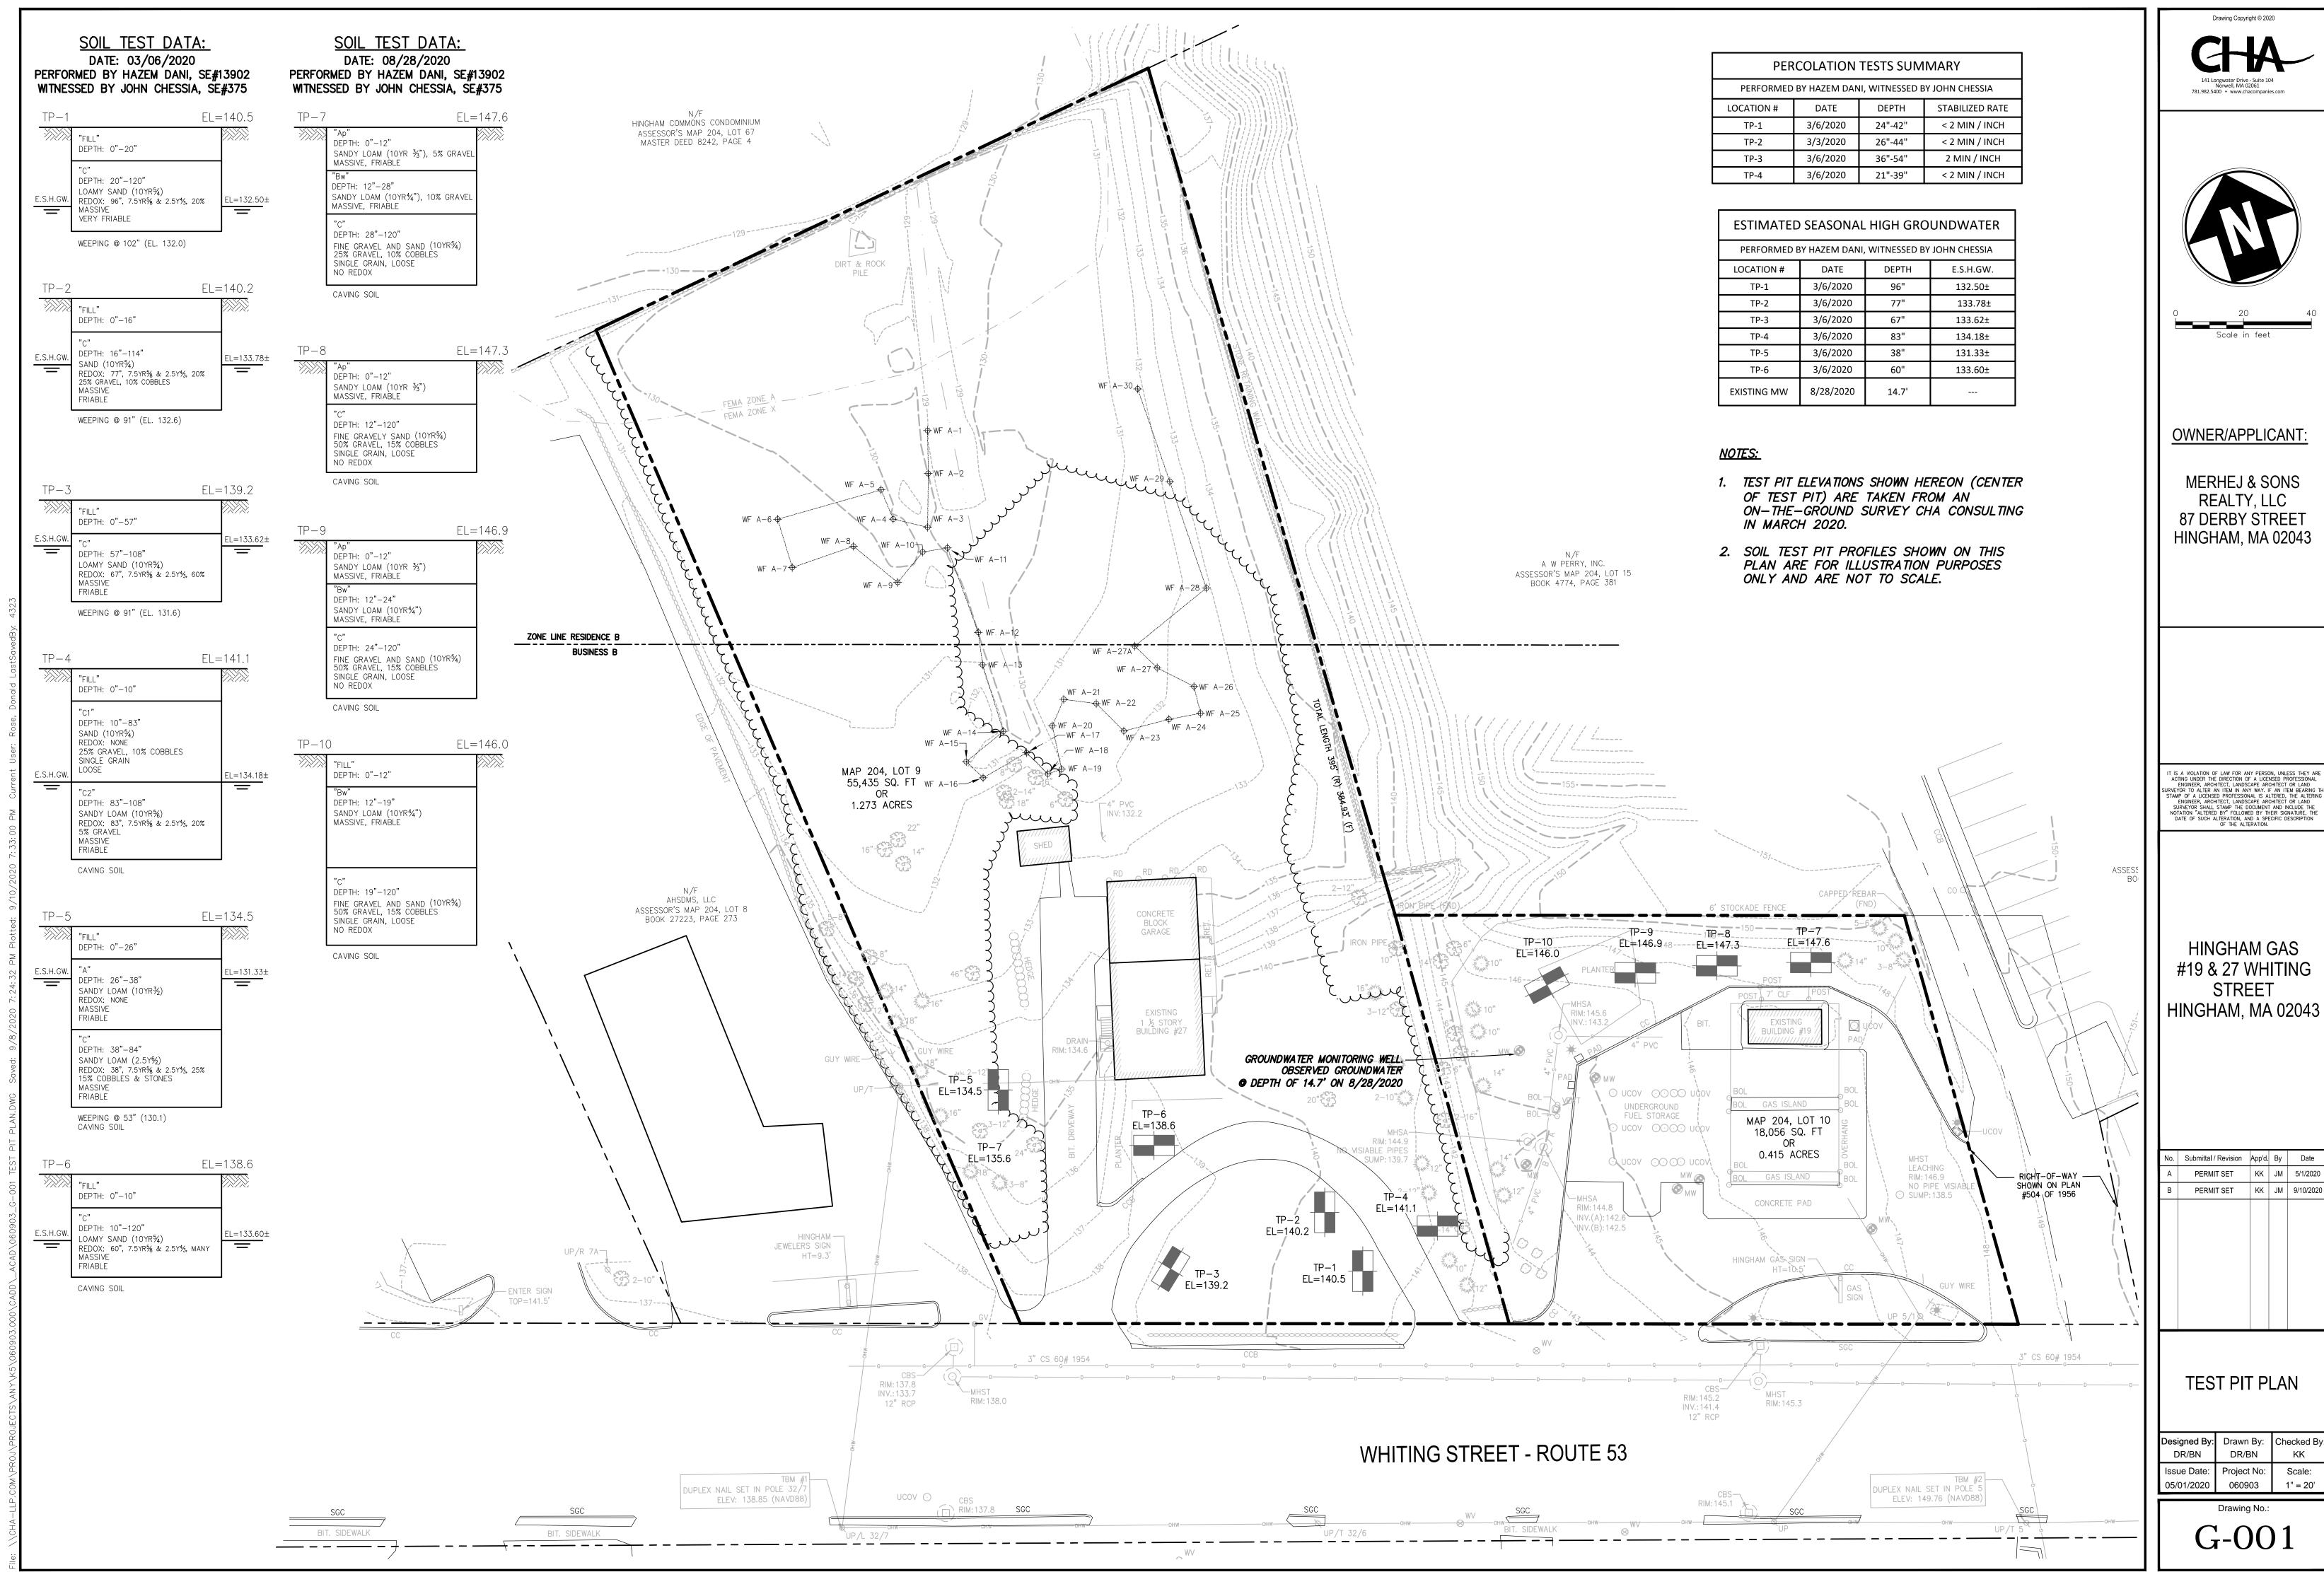




MERHEJ & SONS

HINGHAM GAS #19 & 27 WHITING

Submittal / INEVISION		Бу	Date
PERMIT SET	KK	JM	5/1/2020
PERMIT SET	KK	JM	9/10/2020

esignea By:	Drawn By:	Спескеа ву:
DR/BN	DR/BN	KK
Issue Date:	Project No:	Scale:
05/01/2020	060903	1" = 20'

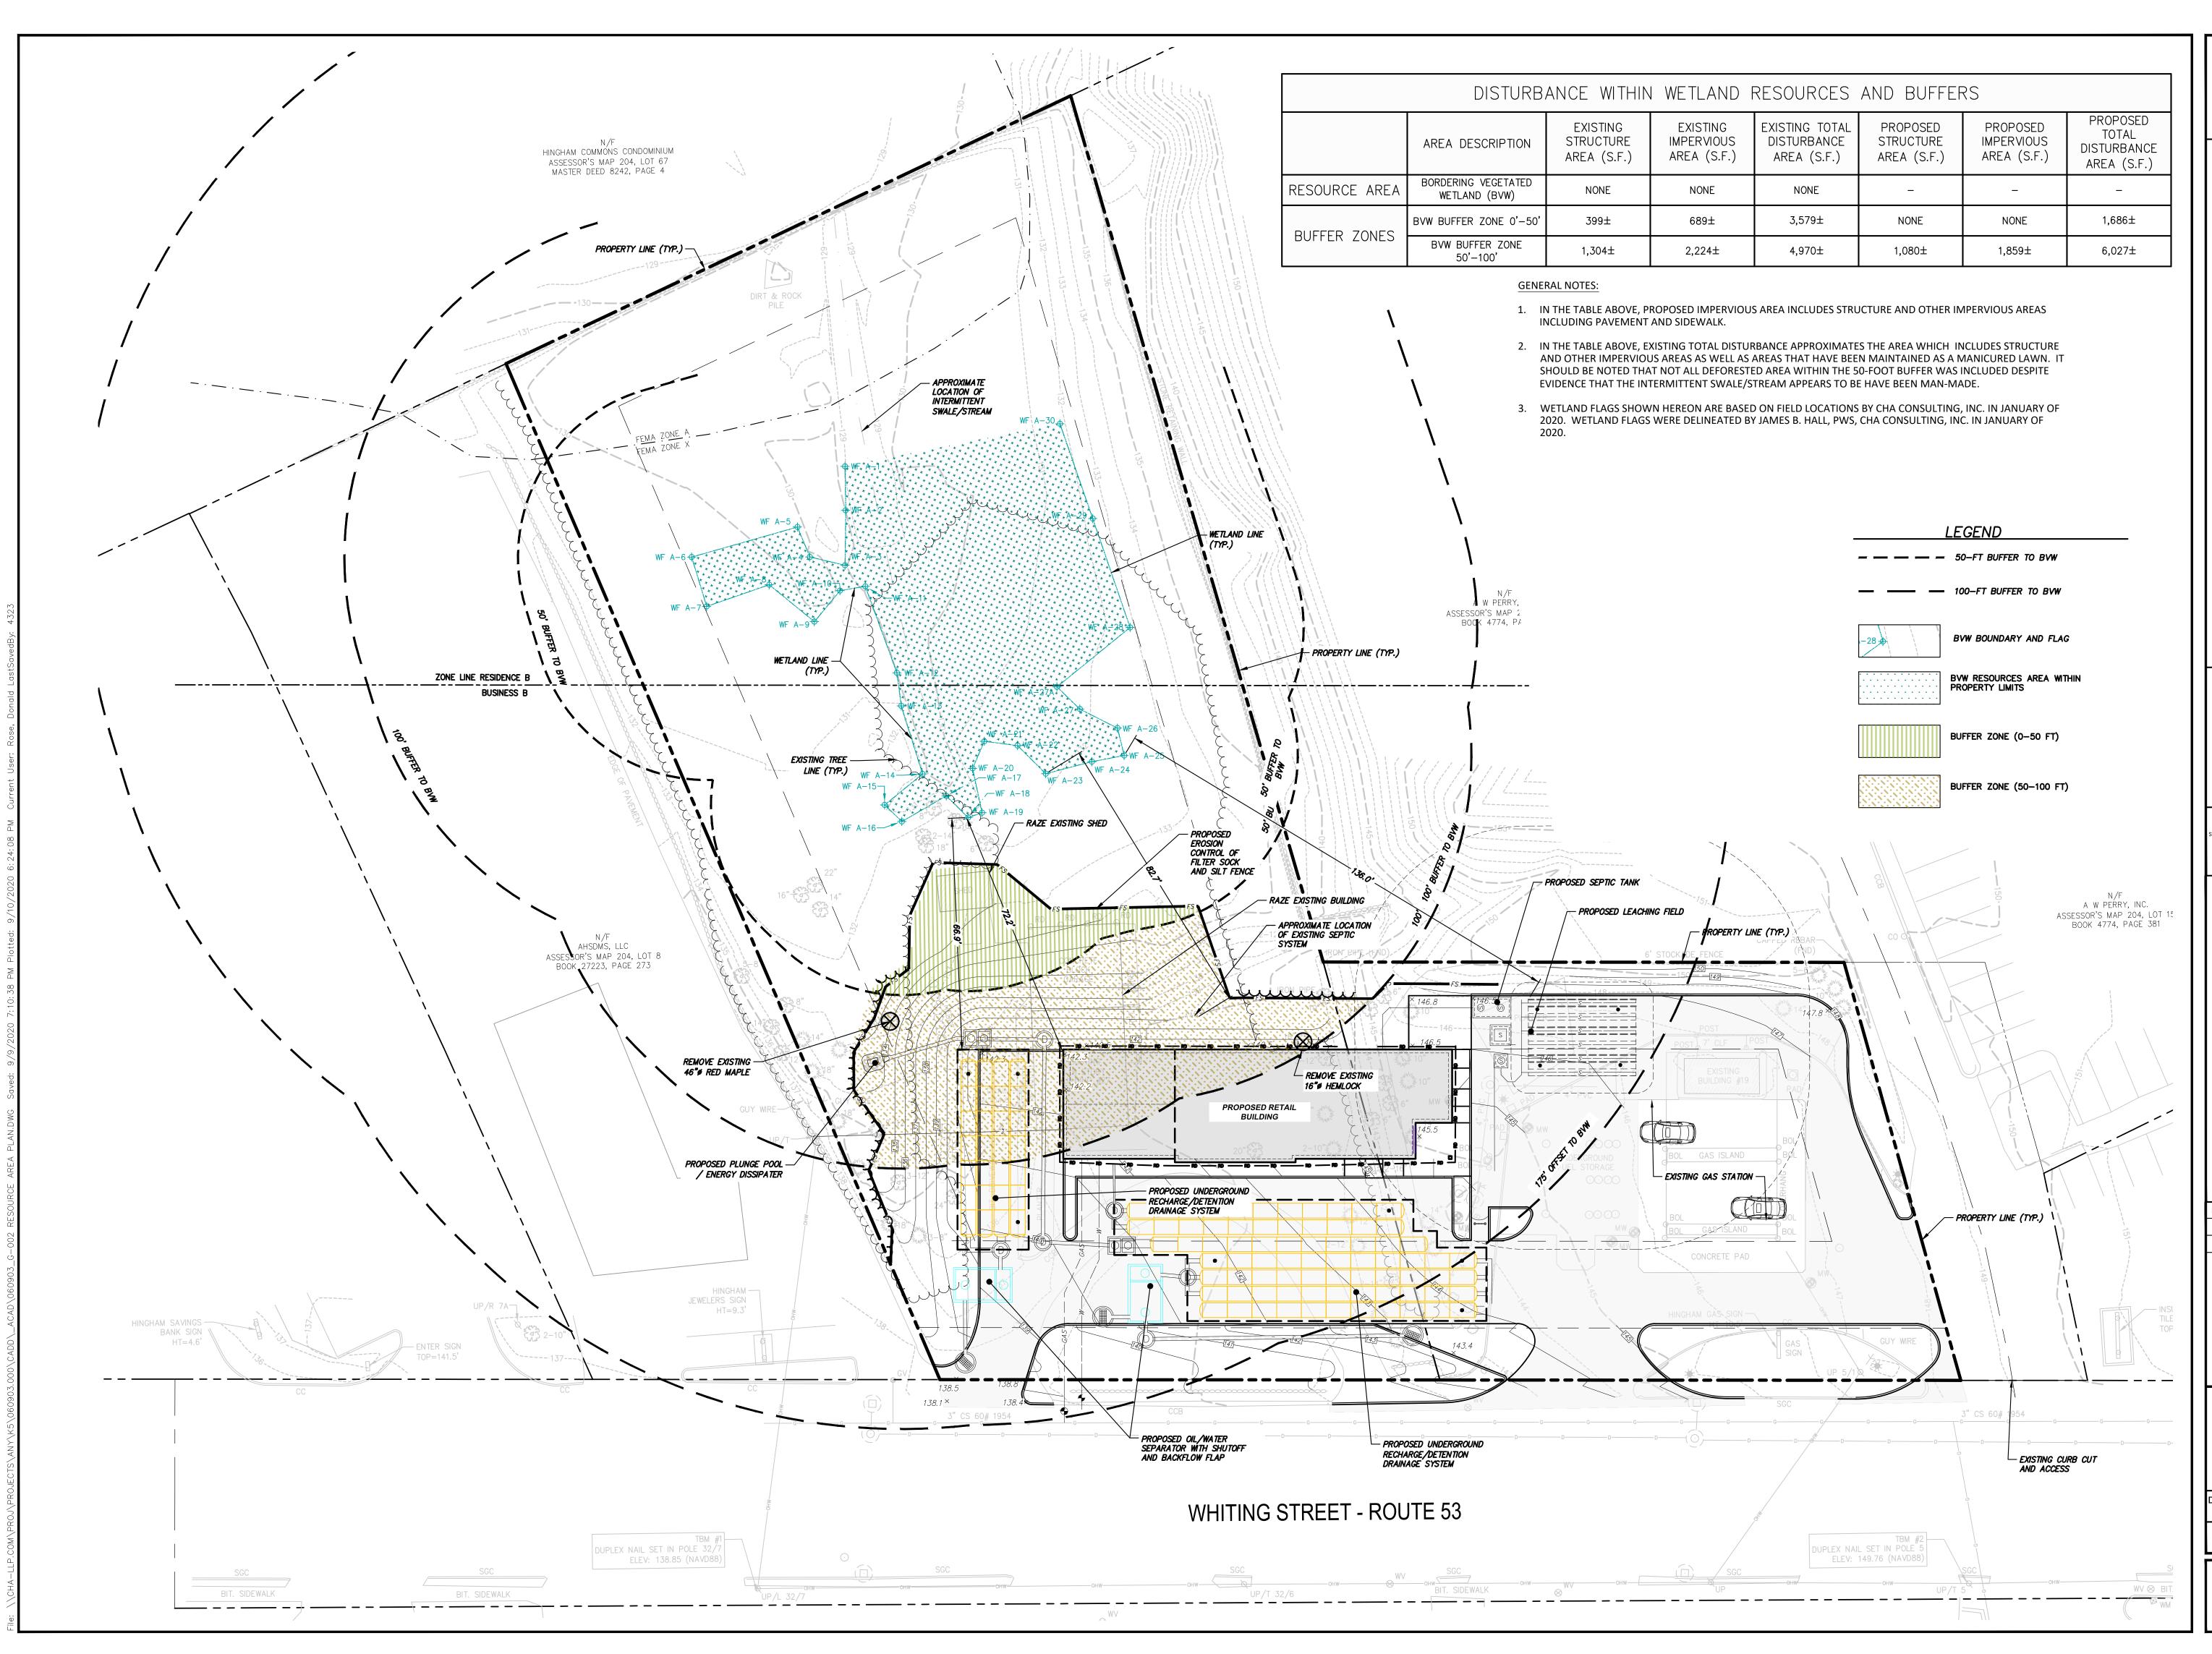





OWNER/APPLICANT:

MERHEJ & SONS REALTY, LLC 87 DERBY STREET HINGHAM, MA 02043



IT IS A VIOLATION OF LAW FOR ANY PERSON, UNLESS THEY ARE ACTING UNDER THE DIRECTION OF A LICENSED PROFESSIONAL ENGINEER, ARCHITECT, LANDSCAPE ARCHITECT OR LAND SURVEYOR TO ALTER AN ITEM IN ANY WAY. IF AN ITEM BEARING THE STAMP OF A LICENSED PROFESSIONAL IS ALTERED, THE ALTERING ENGINEER, ARCHITECT, LANDSCAPE ARCHITECT OR LAND SURVEYOR SHALL STAMP THE DOCUMENT AND INCLUDE THE NOTATION "ALTERED BY" FOLLOWED BY THEIR SIGNATURE, THE DATE OF SUCH ALTERATION, AND A SPECIFIC DESCRIPTION OF THE ALTERATION.

OF THE ALTERATION.

HINGHAM GAS #19 & 27 WHITING STREET HINGHAM, MA 02043

No.	Submittal / Revision	App'd.	Ву	Date
Α	PERMIT SET	KK	JM	5/1/2020
В	PERMIT SET	KK	JM	9/10/2020

RESOURCE AREA PLAN

Designed By:	Drawn By:	Checked By:
DR/BN	DR/BN	KK
Issue Date:	Project No:	Scale:
05/01/2020	060903	1" = 20'



OWNER/APPLICANT:

MERHEJ & SONS REALTY, LLC 87 DERBY STREET HINGHAM, MA 02043


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HINGHAM GAS #19 & 27 WHITING STREET HINGHAM, MA 02043

Submittal / Revision	App'd.	Ву	Date
PERMIT SET	KK	JM	5/1/2020
PERMIT SET	KK	JM	9/10/2020


signed By: DR/BN	Drawn By: DR/BN	Checked By KK
sue Date: 5/01/2020	Project No: 060903	Scale:

Drawing No.:

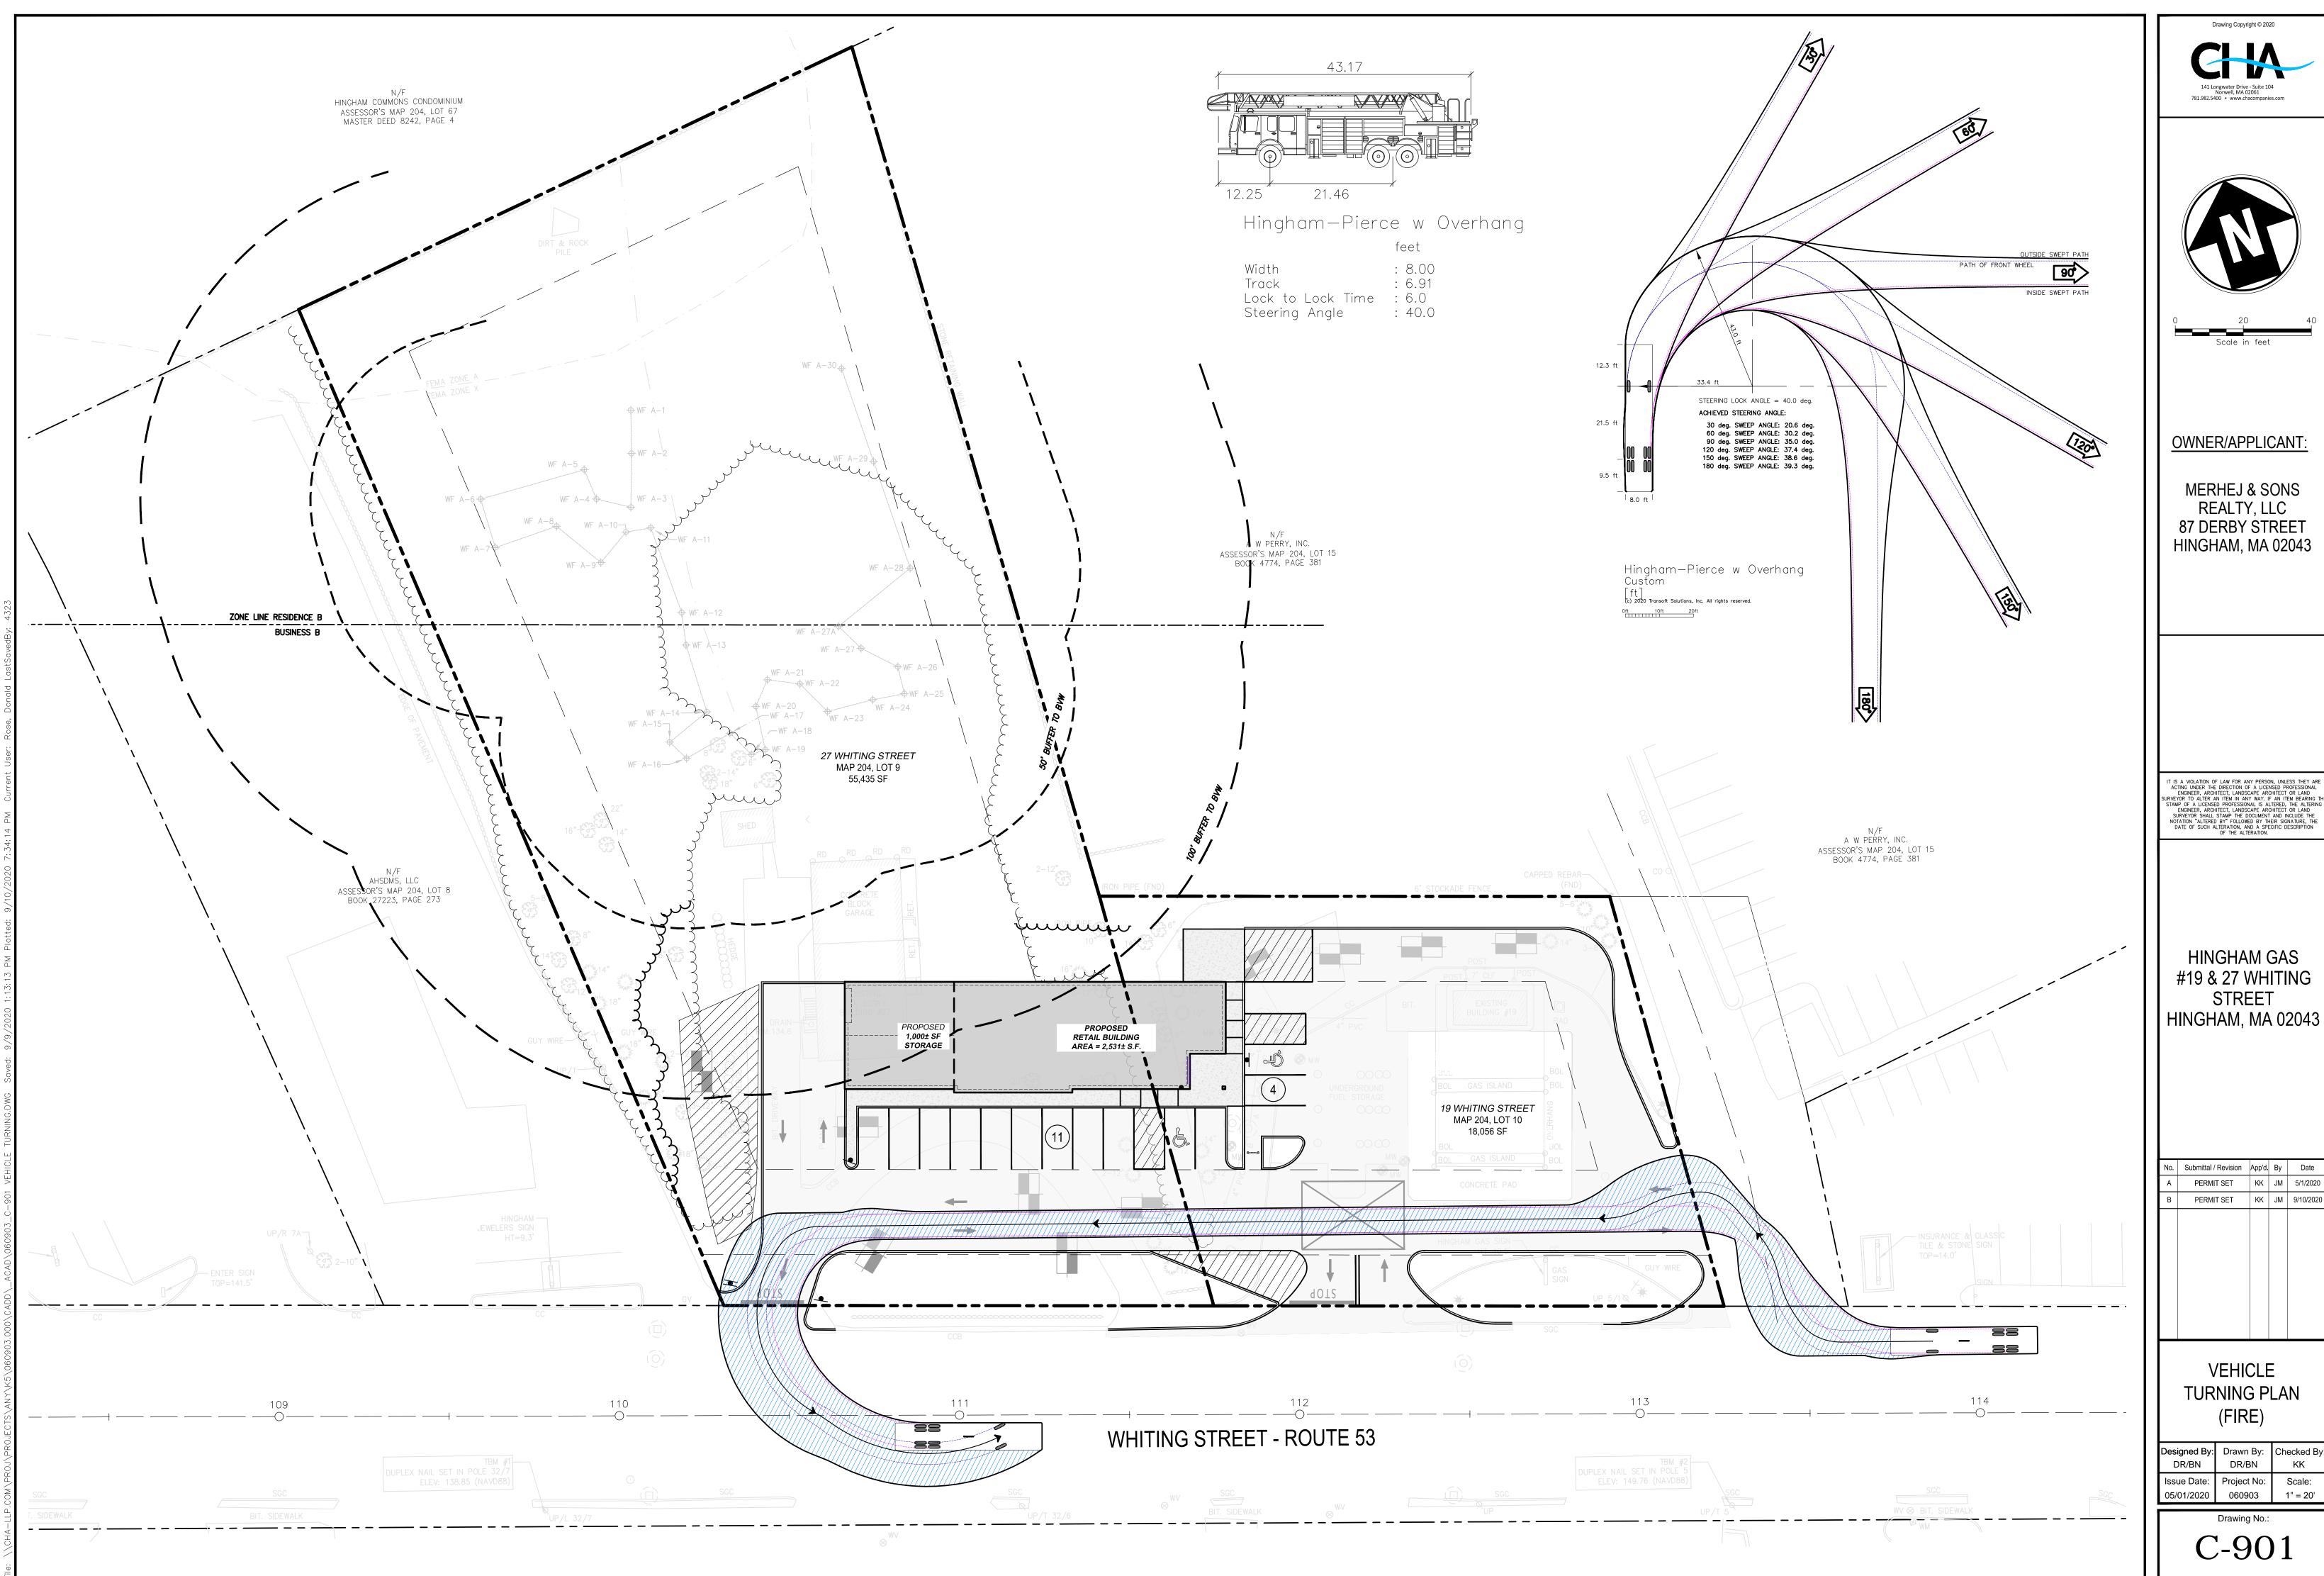


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PERMIT SET	KK	JM	9/10/2020


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DR/BN	DR/BN	KK
ssue Date:	Project No:	Scale:
05/01/2020	060903	1" = 20'

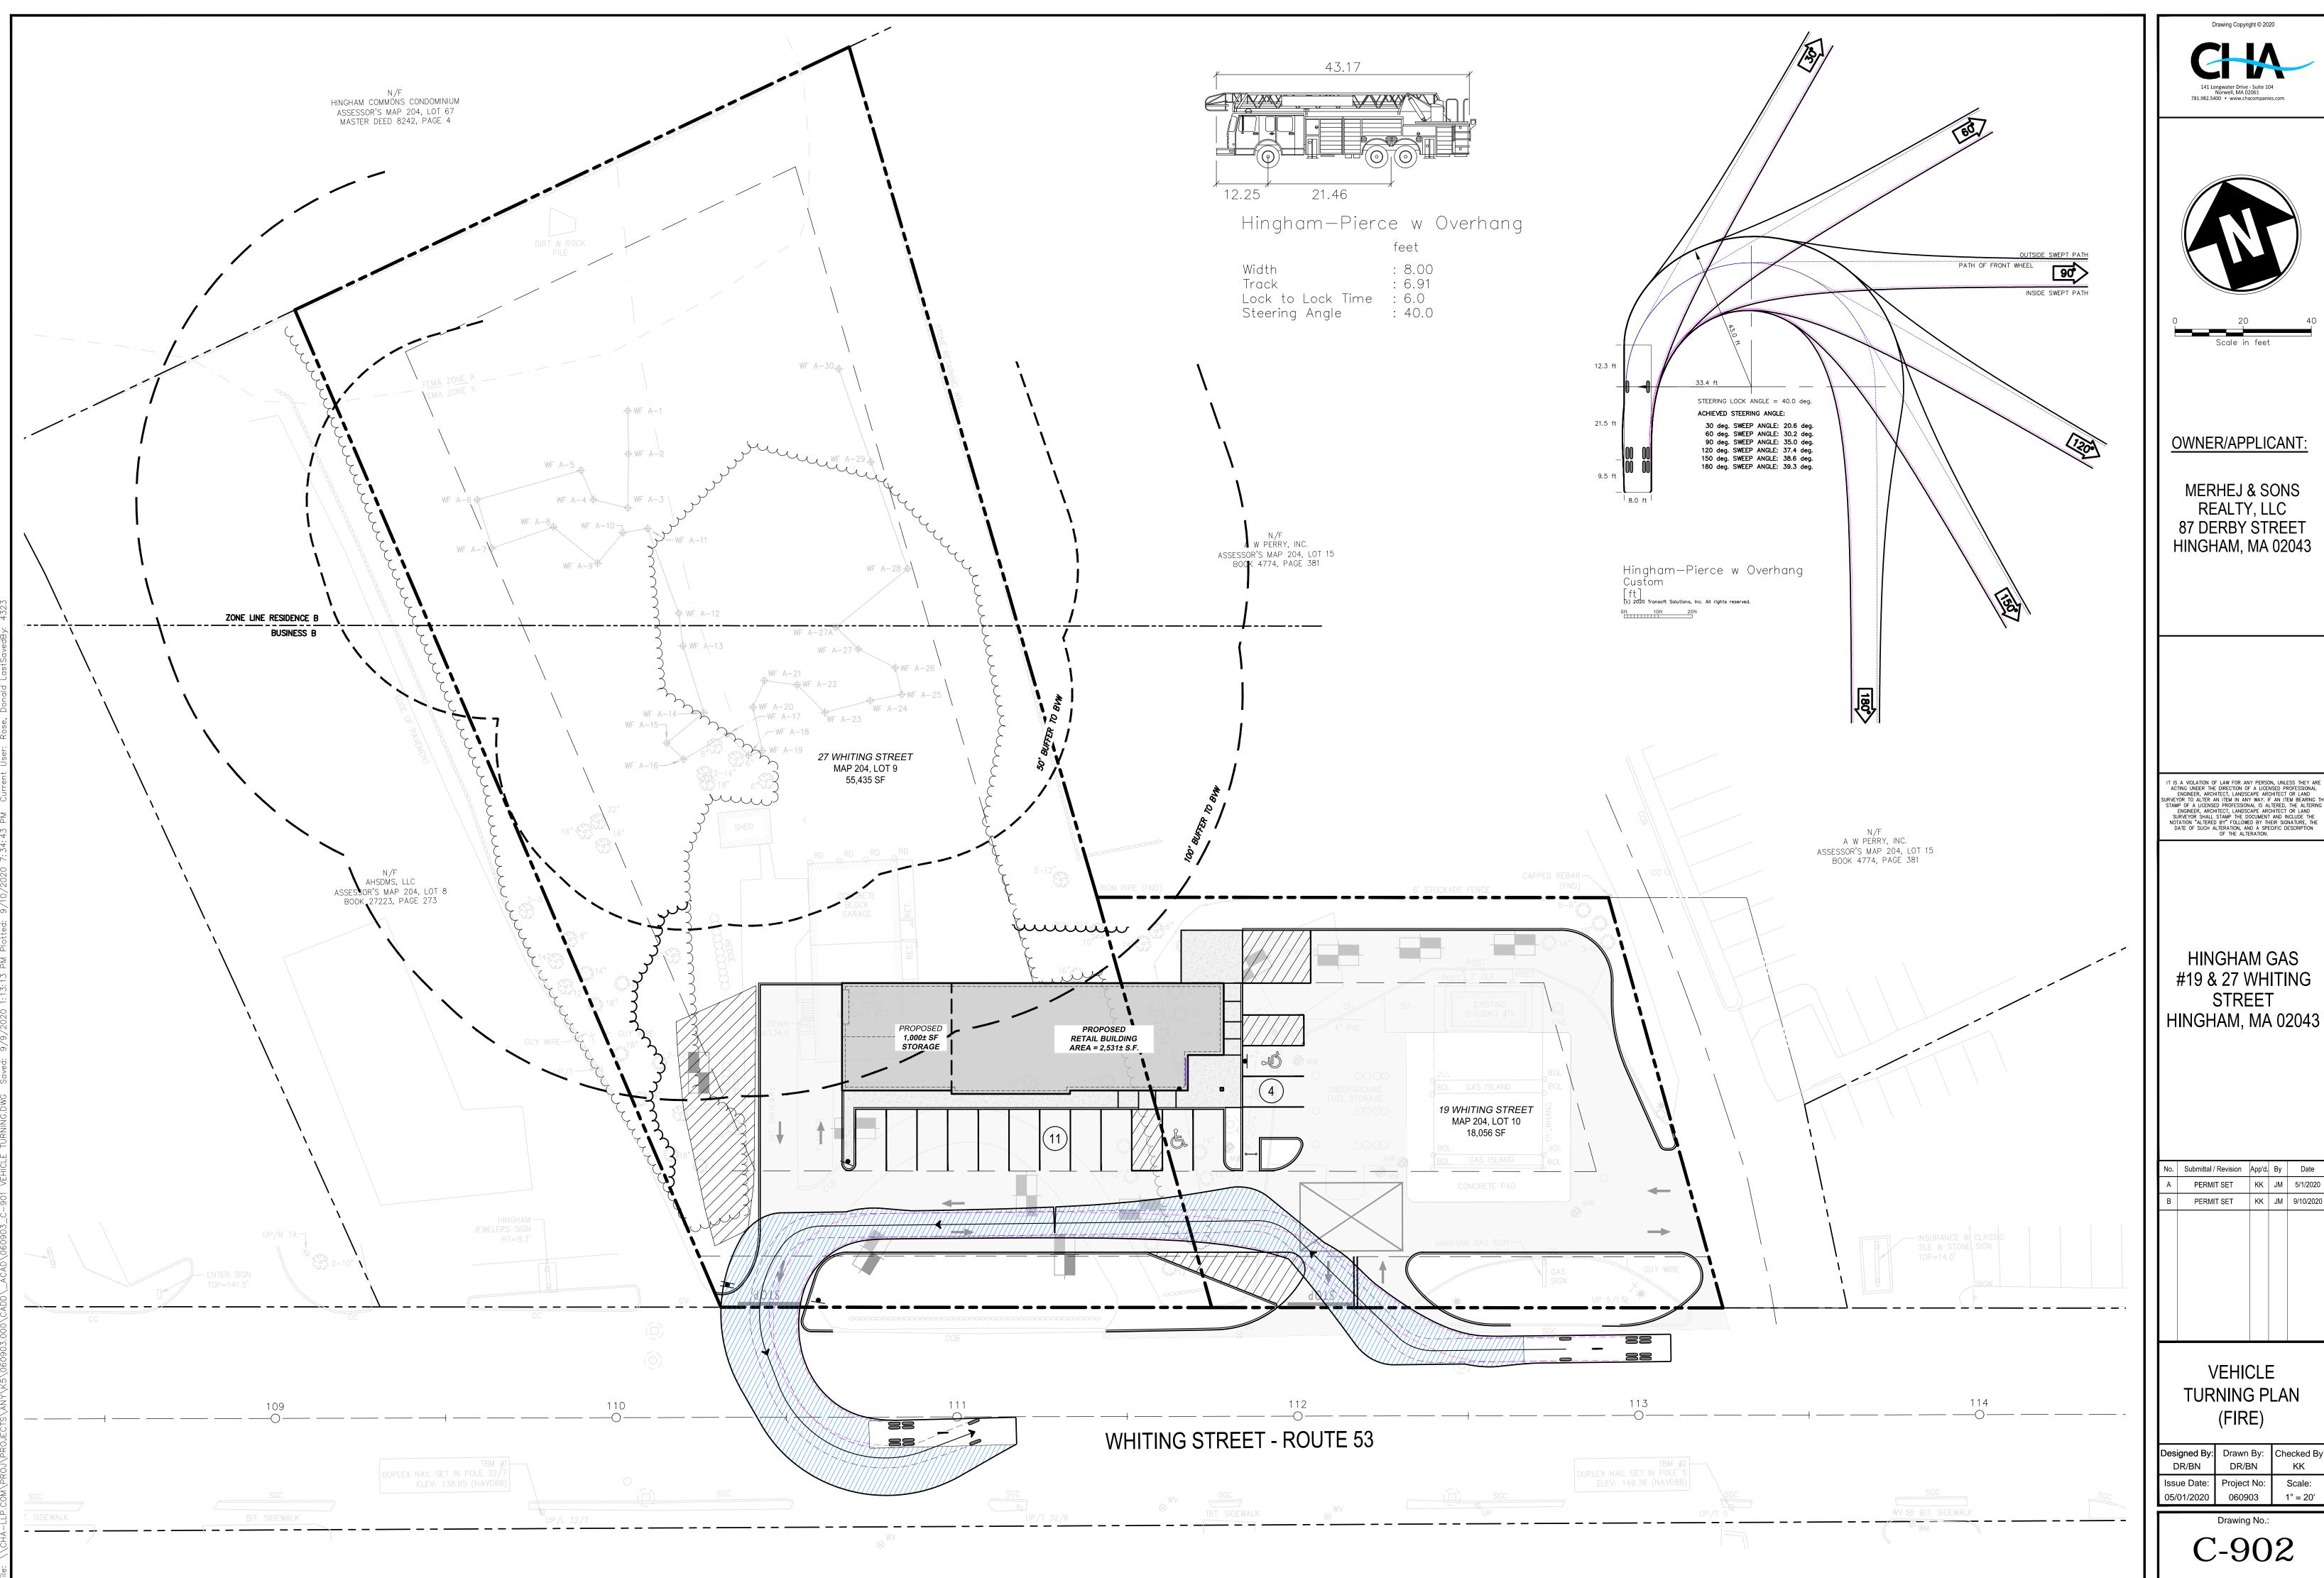


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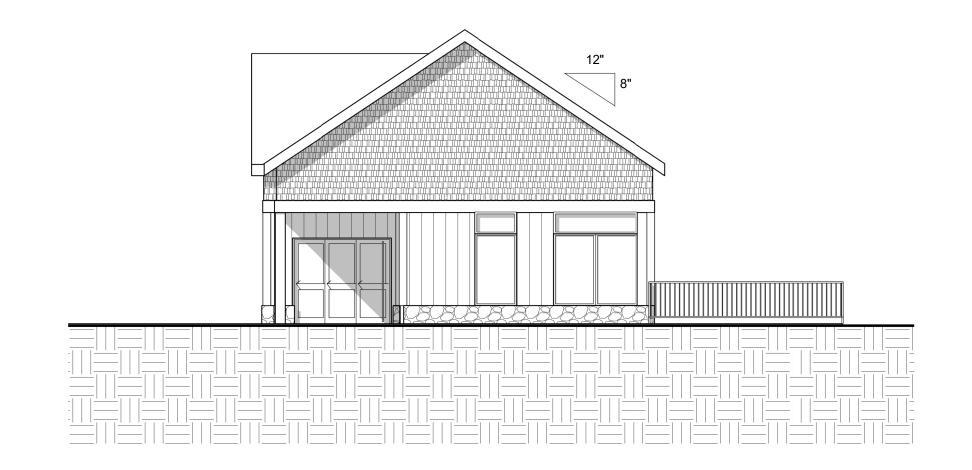

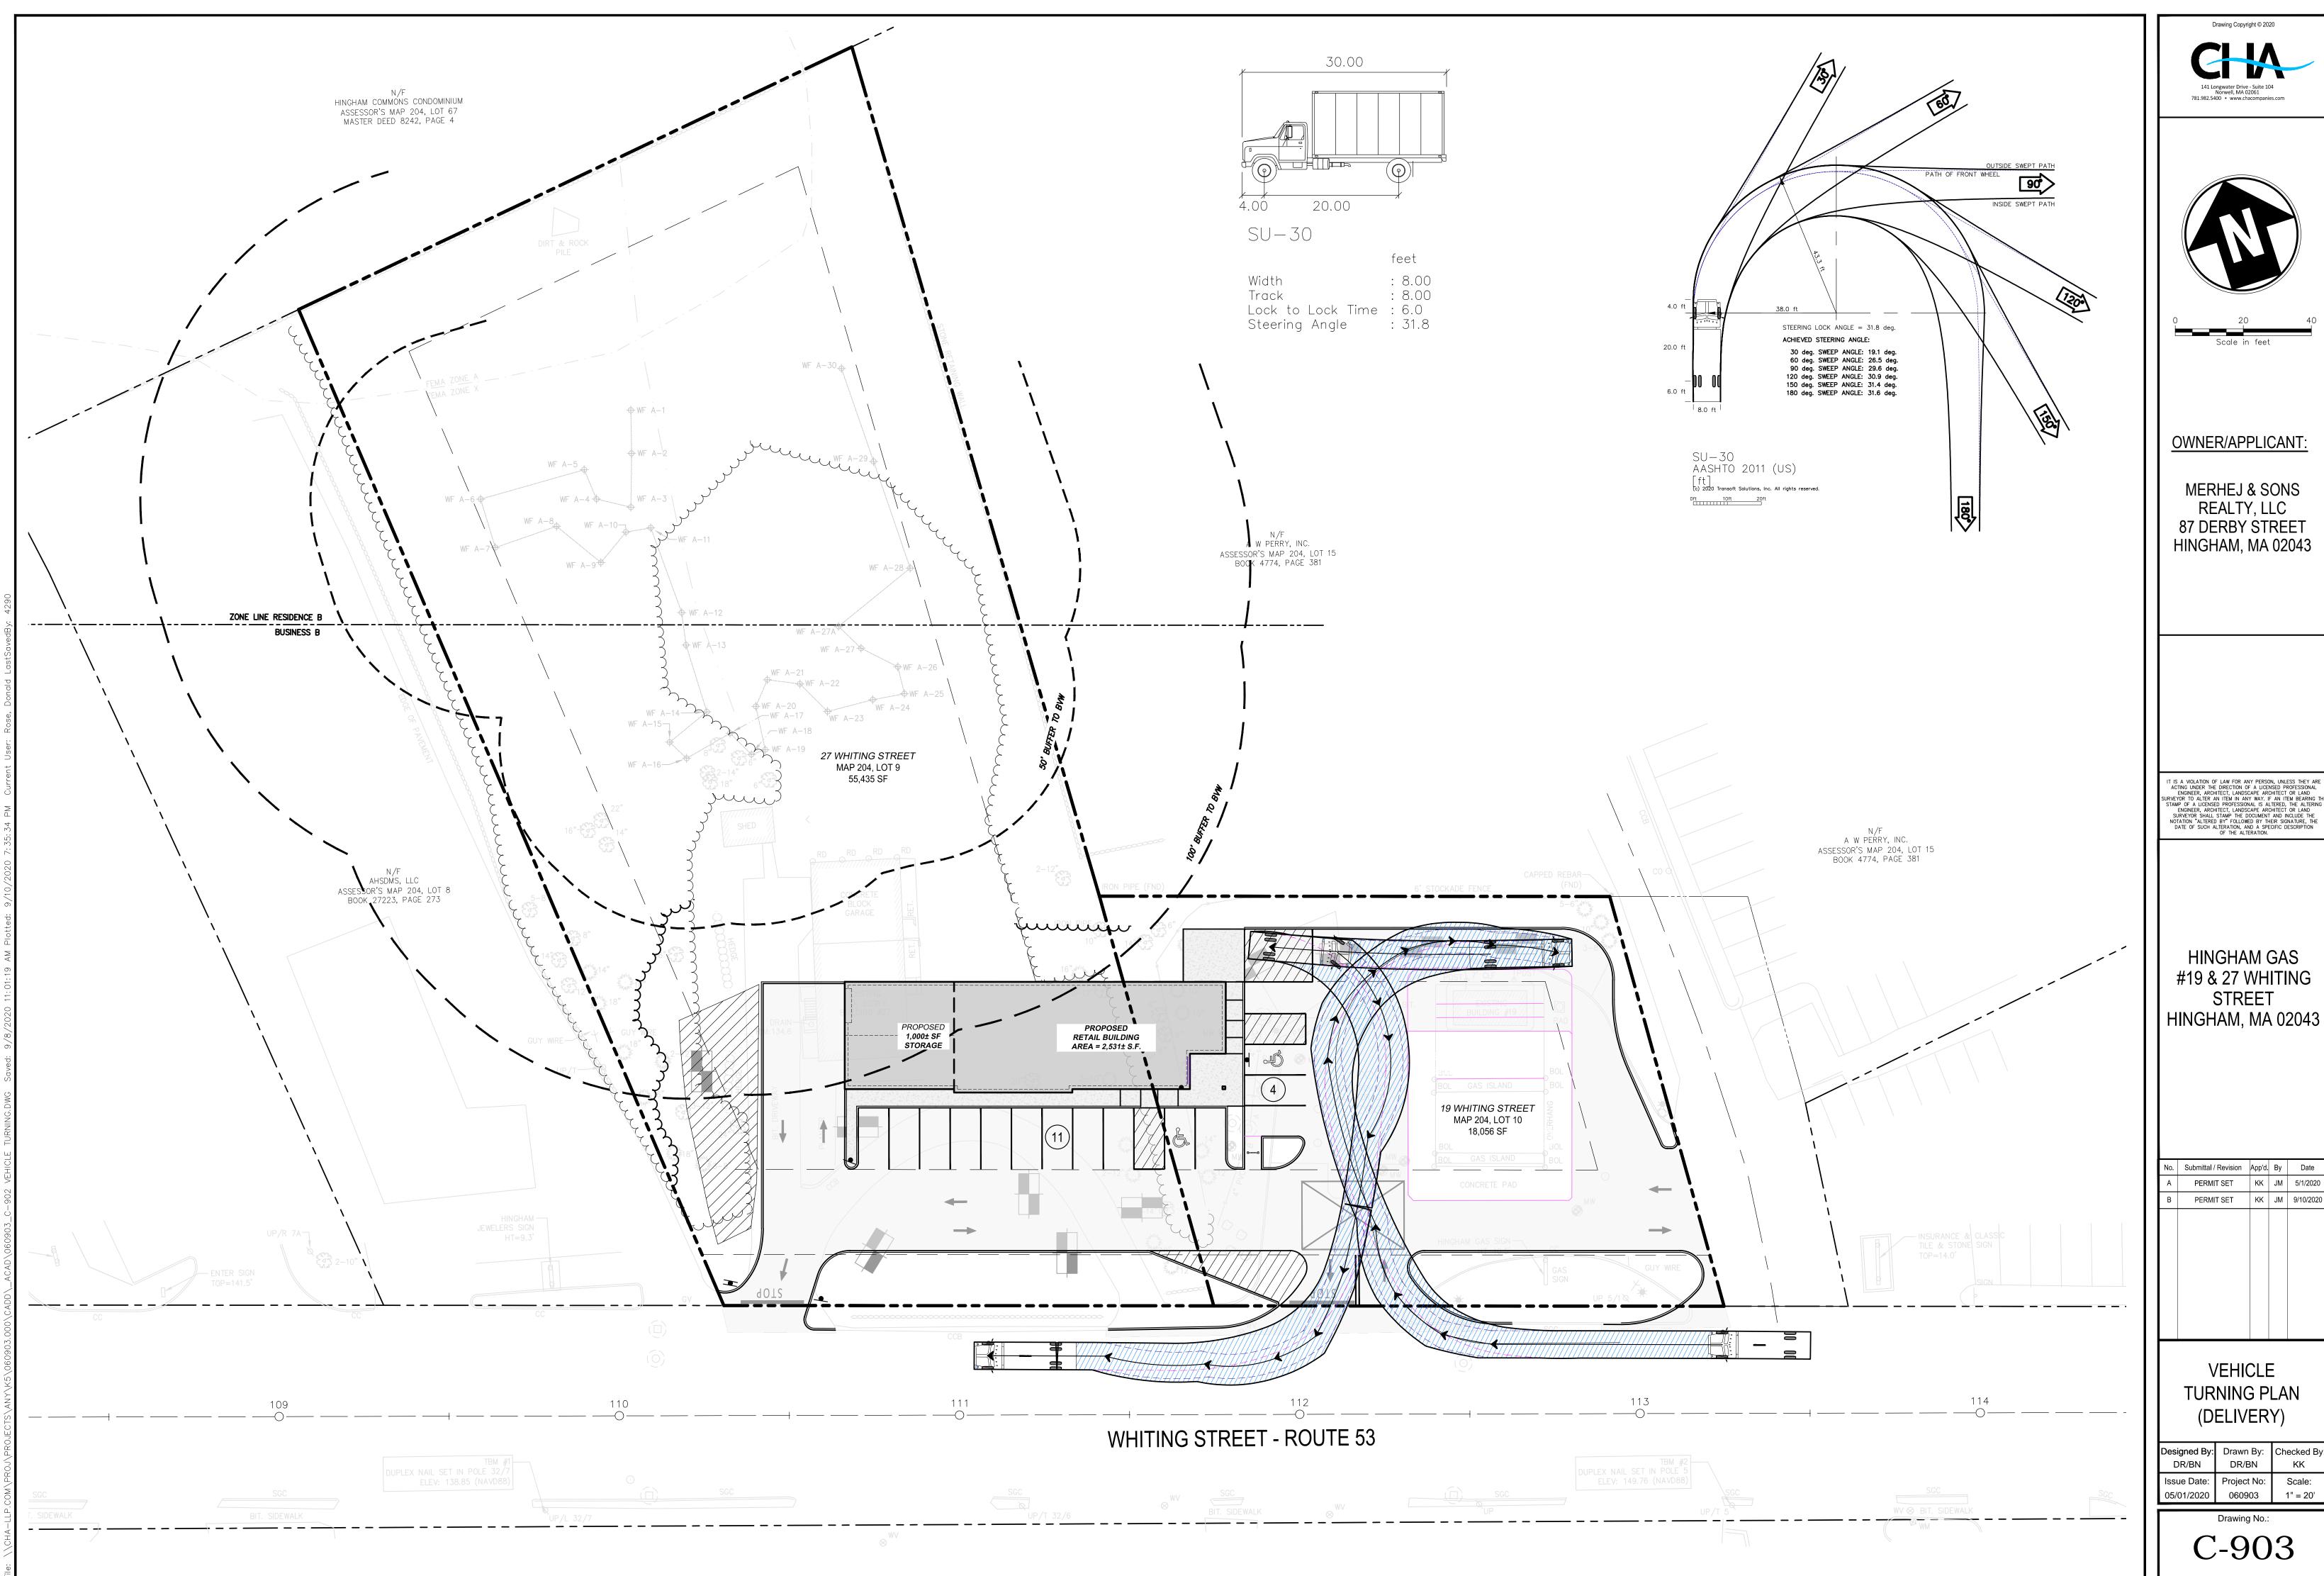
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Submittal / Revision	App'd.	Ву	Date
PERMIT SET	KK	JM	5/1/2020
PERMIT SET	KK	JM	9/10/2020
		·	



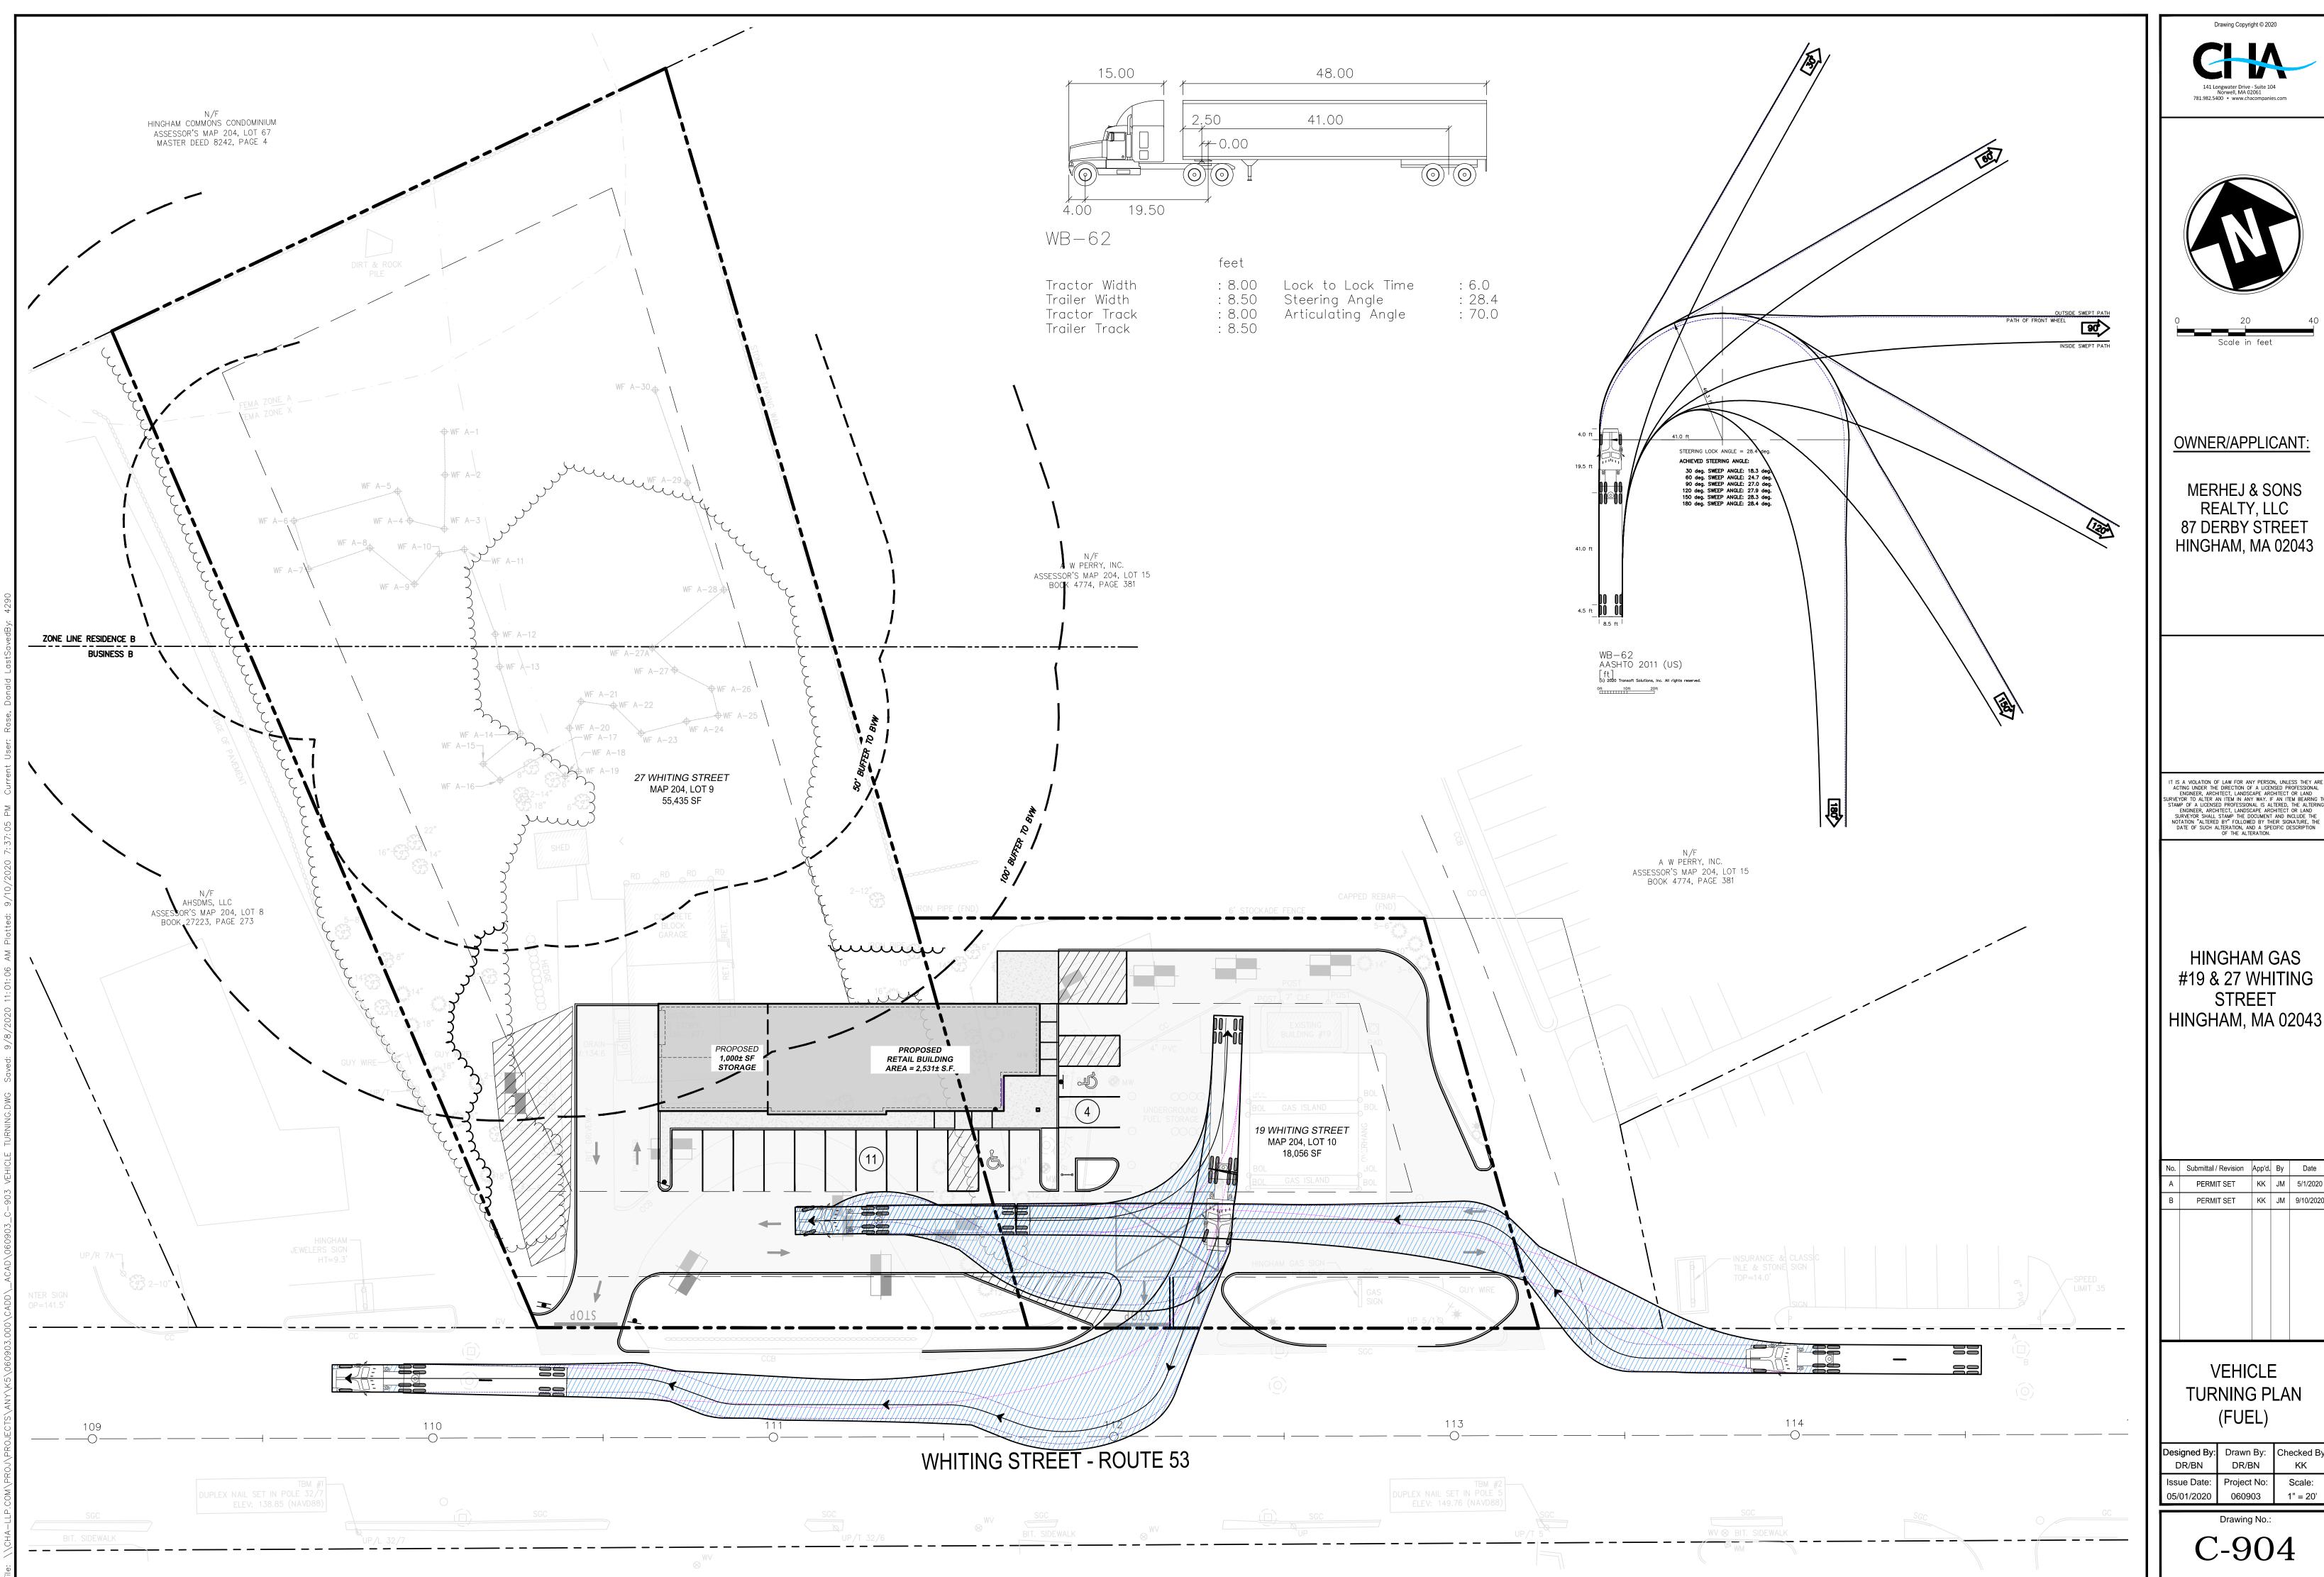

South Elevation

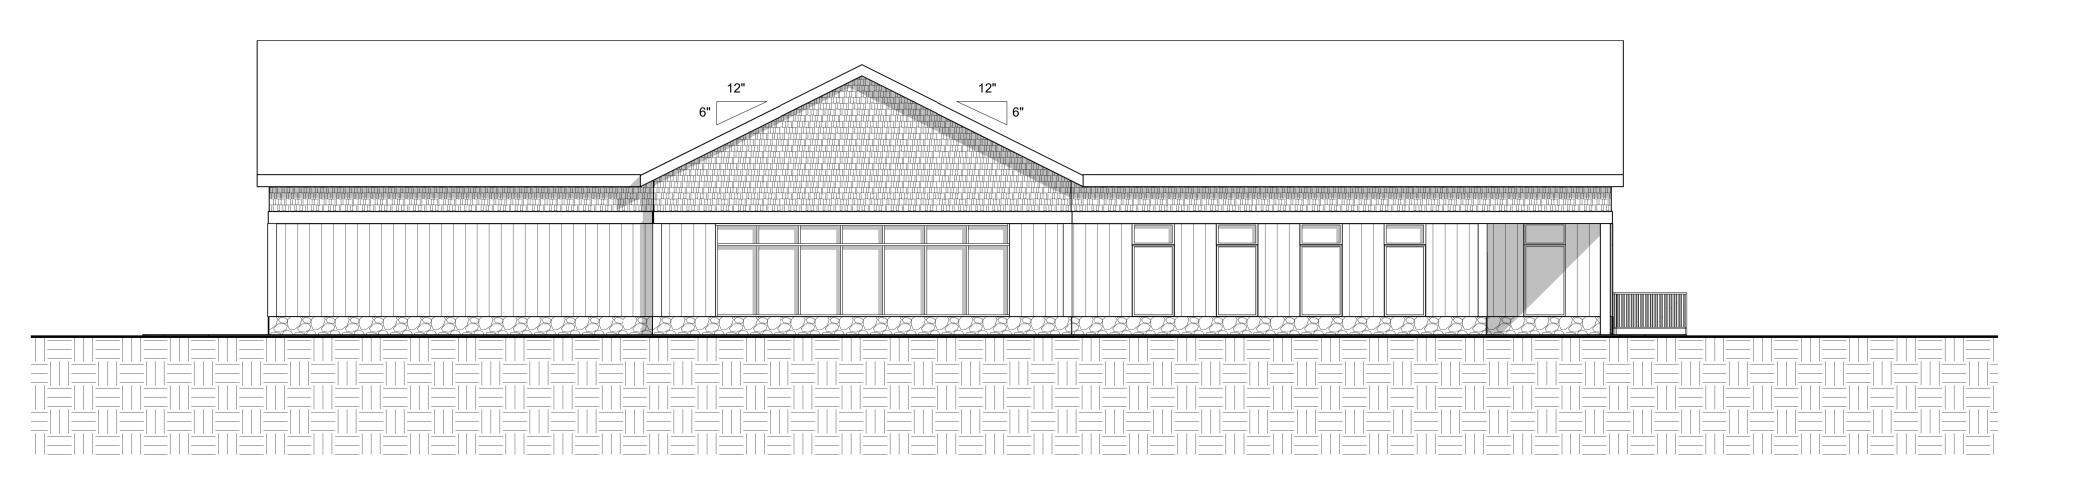1/8" = 1'-0"

East Elevation

1/8" = 1'-0"

